

# Regional Review Notification

## Development of Regional Impact

**DATE:** April 24, 2025

**TO:** CEO Lorraine Cochran-Johnson, DeKalb County Commission

**ATTN TO:** Aprell King, Planner-Long Range Planning, DeKalb County

**RE:** Development of Regional Impact Review

**FROM:** Mike Alexander, COO, Atlanta Regional Commission

*ARC has completed a preliminary regional review of the following DRI. ARC reviewed the DRI's relationship to regional plans, goals and policies as well as impacts the project may have on the activities, plans, goals and policies of other local jurisdictions and state, federal and other agencies. This Preliminary Report does not address whether the DRI is or is not in the best interest of the local government. A Final Report will be issued pending the receipt of stakeholders comments and ARC's completion of its review of the project.*

**Name of Proposal:** Dekalb Concrete Plant DRI 4378  
**Submitting Local Government:** DeKalb County  
**Date Opened:** April 24, 2025 **Comments Due:** May 9, 2025 **Date to Close:** May 9, 2025

**Description:** A DRI review of a proposal to construct a ready-mix concrete plant with operations/office building, batching equipment, material stockpiles, and loading and parking areas on a 3.7 acre site at 3298/3292 Fayetteville Road off of Moreland Avenue in Dekalb County.

### Key Comments

*The project is generally aligned with applicable Established Suburbs growth policy recommendations which emphasize the importance of preserving single-family neighborhoods with appropriate infill development. This project proposes infill industrial development on a mostly previously developed site within a larger industrial park development.*

*The project lies within the Metro South CID and any improvements external to the site should be coordinated with the CID.*

*The existing buffer of natural space with trees along the edges of the site should be retained to the greatest extent possible.*

*There are several nearby MARTA bus stops and MARTA should be included in the design of any roadway improvements affecting the stops.*

*The project is expected to generate approximately 236 daily vehicular trips.*

### General Comments

The Atlanta Region's Plan, developed by ARC in close coordination with partner local governments, is intended to broadly guide regional development in the 11-county metro region to ensure that required infrastructure and resources are in place to support continued economic development and prosperity. The Plan assigns a relevant growth management category designation, or designations, to all areas in the region. This location is designated as Established Suburbs; corresponding growth policy recommendations are detailed at the end of these comments.

The project lies within

the Metro South CID and any improvements external to the site should be coordinated with the CID.

### **Transportation and Mobility Comments**

Transportation and Mobility comments will be provided in the Final Report.

The project is expected to generate approximately 236 daily vehicular trips.

There are several nearby MARTA bus stops and MARTA should be included in the design of any roadway improvements affecting the stops.

### **ARC Natural Resources Group Comment**

ARC's Natural Resource comments will be provided in the Final Report.

### **Environmental Comments**

The existing buffer of natural space with trees along the edges of the site should be retained to the greatest extent possible.

The project can support The Atlanta Region's Plan in general by incorporating other aspects of regional policy, including green infrastructure and/or low-impact design, e.g., pervious pavers, rain gardens, vegetated swales, etc., in parking areas and site driveways, and as part of any improvements to site frontages.

### **Atlanta Region's Plan Growth Policy Considerations: Established Suburbs**

According to the Atlanta Region's Plan, Established Suburbs are areas where suburban development has occurred and are characterized by single-family subdivisions, commercial development, and office, industrial and multi-family development. These areas represent the part of the region that has recently reached "build-out." With few remaining large parcels for additional development, these are the areas in which the region may see the least amount of land-use change outside of retail and commercial areas. While there is still room for limited infill development, these areas will begin to focus more on redevelopment over the next 30 years.

Preservation of existing single-family neighborhoods is important, and wholesale change will most likely not occur in the single-family subdivisions that make up a majority of these areas. However, infill and redevelopment will occur in areas of retail/commercial concentrations, especially commercial corridors.

The project is generally aligned with Established Suburbs recommendations in its reuse of an existing industrial site that doesn't impact nearby single-family neighborhoods. Dekalb County leadership and staff, along with the applicant team, should collaborate closely to ensure maximum sensitivity to the needs of nearby local governments, neighborhoods, land uses and natural systems.

### **The Following Local Governments and Agencies Received Notice of This Review:**

Atlanta Regional Commission	Georgia Department of Natural Resource	City of Atlanta
Georgia Department of Community Affairs	Georgia Conservancy	Georgia Env. Facilities Authority
Georgia Department of Transportation	Dekalb County	City of Atlanta
MARTA	Metro South CID	

For questions, please contact Donald Shockey at (470) 378-1531 or [dshockey@atlantaregional.org](mailto:dshockey@atlantaregional.org).

This finding will be published to the ARC review website located at <http://atlantaregional.org/plan-reviews>.



### Developments of Regional Impact

- [DRI Home](#)
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**DRI #4378**

#### DEVELOPMENT OF REGIONAL IMPACT Initial DRI Information

This form is to be completed by the city or county government to provide basic project information that will allow the RDC to determine if the project appears to meet or exceed applicable DRI thresholds. Refer to both the [Rules for the DRI Process](#) and the [DRI Tiers and Thresholds](#) for more information.

#### Local Government Information

Submitting Local Government: DeKalb  
 Individual completing form: Aprell King  
 Telephone: (470) 898-2251  
 E-mail: [alking@dekalbcountyga.gov](mailto:alking@dekalbcountyga.gov)

\*Note: The local government representative completing this form is responsible for the accuracy of the information contained herein. If a project is to be located in more than one jurisdiction and, in total, the project meets or exceeds a DRI threshold, the local government in which the largest portion of the project is to be located is responsible for initiating the DRI review process.

#### Proposed Project Information

Name of Proposed Project: DeKalb Concrete Plant  
 Location (Street Address, GPS Coordinates, or Legal Land Lot Description): 3298 & 3273 Fayetteville Road, Atlanta, GA  
 Brief Description of Project: A DRI review of a proposal to construct a ready-mix concrete plant with operations/office building, batching equipment, material stockpiles, and loading and parking areas on a 3.7 acre site at 3298/3292 Fayetteville Road off of Moreland Avenue in DeKalb County.

#### Development Type:

- |  |  |   |
|--|--|---|
| <input type="radio"/> (not selected)                       | <input type="radio"/> Hotels                                       | <input type="radio"/> Wastewater Treatment Facilities |
| <input type="radio"/> Office                               | <input type="radio"/> Mixed Use                                    | <input type="radio"/> Petroleum Storage Facilities    |
| <input type="radio"/> Commercial                           | <input type="radio"/> Airports                                     | <input type="radio"/> Water Supply Intakes/Reservoirs |
| <input type="radio"/> Wholesale & Distribution             | <input type="radio"/> Attractions & Recreational Facilities        | <input type="radio"/> Intermodal Terminals            |
| <input type="radio"/> Hospitals and Health Care Facilities | <input type="radio"/> Post-Secondary Schools                       | <input type="radio"/> Truck Stops                     |
| <input type="radio"/> Housing                              | <input type="radio"/> Waste Handling Facilities                    | <input type="radio"/> Any other development types     |
| <input type="radio"/> Industrial                           | <input checked="" type="radio"/> Quarries, Asphalt & Cement Plants |   |

If other development type, describe:

Project Size (# of units, floor area, etc.): 3.7 acres  
 Developer: Hollingshead Materials, LLC c/o Brian Hercules  
 Mailing Address: 1000 Hollingshead Circle  
 Address 2:  
 City: Murfreesboro State: TN Zip: 37167  
 Telephone: 615-624-1221  
 Email: [Brian.Hercules@smyrmareadymix.com](mailto:Brian.Hercules@smyrmareadymix.com)

Is property owner different from developer/applicant?  (not selected)  Yes  No

If yes, property owner: Ehsan Razavi

Is the proposed project entirely located within your  (not selected)  Yes  No

local government's jurisdiction?

If no, in what additional jurisdictions is the project located?

Is the current proposal a continuation or expansion of a previous DRI?  (not selected)  Yes  No

If yes, provide the following information: Project Name:  
Project ID:

The initial action being requested of the local government for this project:

- Rezoning
- Variance
- Sewer
- Water
- Permit
- Other

Is this project a phase or part of a larger overall project?  (not selected)  Yes  No

If yes, what percent of the overall project does this project/phase represent?

Estimated Project Completion Dates: This project/phase: Upon closing of the site, 180 to 270 days start to completion.  
Overall project: Upon closing of the site, 180 to 270 days start to completion.

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[DRI Home](#)

[Tier Map](#)

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**DRI #4378**

### DEVELOPMENT OF REGIONAL IMPACT Additional DRI Information

This form is to be completed by the city or county government to provide information needed by the RDC for its review of the proposed DRI. Refer to both the [Rules for the DRI Process](#) and the [DRI Tiers and Thresholds](#) for more information.

#### Local Government Information

Submitting Local Government: DeKalb  
 Individual completing form: Aprell King  
 Telephone: (470) 898-2251  
 Email: [alking@dekalbcountyga.gov](mailto:alking@dekalbcountyga.gov)

#### Project Information

Name of Proposed Project: DeKalb Concrete Plant  
 DRI ID Number: 4378  
 Developer/Applicant: Hollingshead Materials, LLC c/o Brian Hercules  
 Telephone: 615-624-1221  
 Email(s): [Brian.Hercules@smymareadymix.com](mailto:Brian.Hercules@smymareadymix.com)

#### Additional Information Requested

Has the RDC identified any additional information required in order to proceed with the official regional review process? (If no, proceed to Economic Impacts.)  
 (not selected)  Yes  No

If yes, has that additional information been provided to your RDC and, if applicable, GRITA?  
 (not selected)  Yes  No

If no, the official review process can not start until this additional information is provided.

#### Economic Development

Estimated Value at Build-Out: \$23 - \$24 Million

Estimated annual local tax revenues (i.e., property tax, sales tax) likely to be generated by the proposed development: \$174,000

Is the regional work force sufficient to fill the demand created by the proposed project?  
 (not selected)  Yes  No

Will this development displace any existing uses?  
 (not selected)  Yes  No

If yes, please describe (including number of units, square feet, etc):

#### Water Supply

Name of water supply provider for this site: DeKalb County

What is the estimated water supply demand to be generated by the project, measured in Millions of Gallons Per Day (MGD)? Estimated consumption of 10,000 gallons per day

Is sufficient water supply capacity available to serve the proposed project?  (not selected)  Yes  No

If no, describe any plans to expand the existing water supply capacity:

Is a water line extension required to serve this project?  (not selected)  Yes  No

If yes, how much additional line (in miles) will be required?

### Wastewater Disposal

Name of wastewater treatment provider for this site: DeKalb County

What is the estimated sewage flow to be generated by the project, measured in Millions of Gallons Per Day (MGD)? .00075 MGD or 750 gallons per day

Is sufficient wastewater treatment capacity available to serve this proposed project?  (not selected)  Yes  No

If no, describe any plans to expand existing wastewater treatment capacity:

Is a sewer line extension required to serve this project?  (not selected)  Yes  No

If yes, how much additional line (in miles) will be required?

### Land Transportation

How much traffic volume is expected to be generated by the proposed development, in peak hour vehicle trips per day? (If only an alternative measure of volume is available, please provide.) ADT is less than 1,000 - Calculated ADT: (236)

Has a traffic study been performed to determine whether or not transportation or access improvements will be needed to serve this project?  (not selected)  Yes  No

Are transportation improvements needed to serve this project?  (not selected)  Yes  No

If yes, please describe below: A roundabout is being constructed in 2025 to improve the overall intersection & traffic flow adjacent to the site. The access drive is being shifted away from new roundabout to allow for better separation and safety for ingress and egress operation.

### Solid Waste Disposal

How much solid waste is the project expected to generate annually (in tons)? 2 tons

Is sufficient landfill capacity available to serve this proposed project?  (not selected)  Yes  No

If no, describe any plans to expand existing landfill capacity:

Will any hazardous waste be generated by the development?  (not selected)  Yes  No

If yes, please explain:

### Stormwater Management

What percentage of the site is projected to be impervious surface once the proposed development has been constructed? 70%

Describe any measures proposed (such as buffers, detention or retention ponds, pervious parking areas) to mitigate the project's impacts on stormwater management: Detention pond & water quality measures will be employed to control quality & quantity of storm water discharge.

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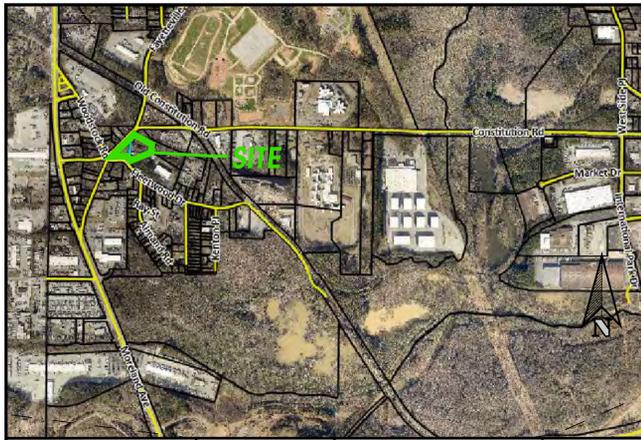
### Environmental Quality

Is the development located within, or likely to affect any of the following:

- 1. Water supply watersheds?  (not selected)  Yes  No
- 2. Significant groundwater recharge areas?  (not selected)  Yes  No
- 3. Wetlands?  (not selected)  Yes  No
- 4. Protected mountains?  (not selected)  Yes  No
- 5. Protected river corridors?  (not selected)  Yes  No
- 6. Floodplains?  (not selected)  Yes  No
- 7. Historic resources?  (not selected)  Yes  No
- 8. Other environmentally sensitive resources?  (not selected)  Yes  No

If you answered yes to any question above, describe how the identified resource(s) may be affected:

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VICINITY MAP

SCALE: N.T.S.




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 WETLAND & ENVIRONMENTAL MONITORING



GSWCC LEVEL II  
 CERTIFIED DESIGN  
 PROF. #0000010490  
 EXPIRES: 12-19-27

**SITE PLAN**  
 GRTA DRI # 4378

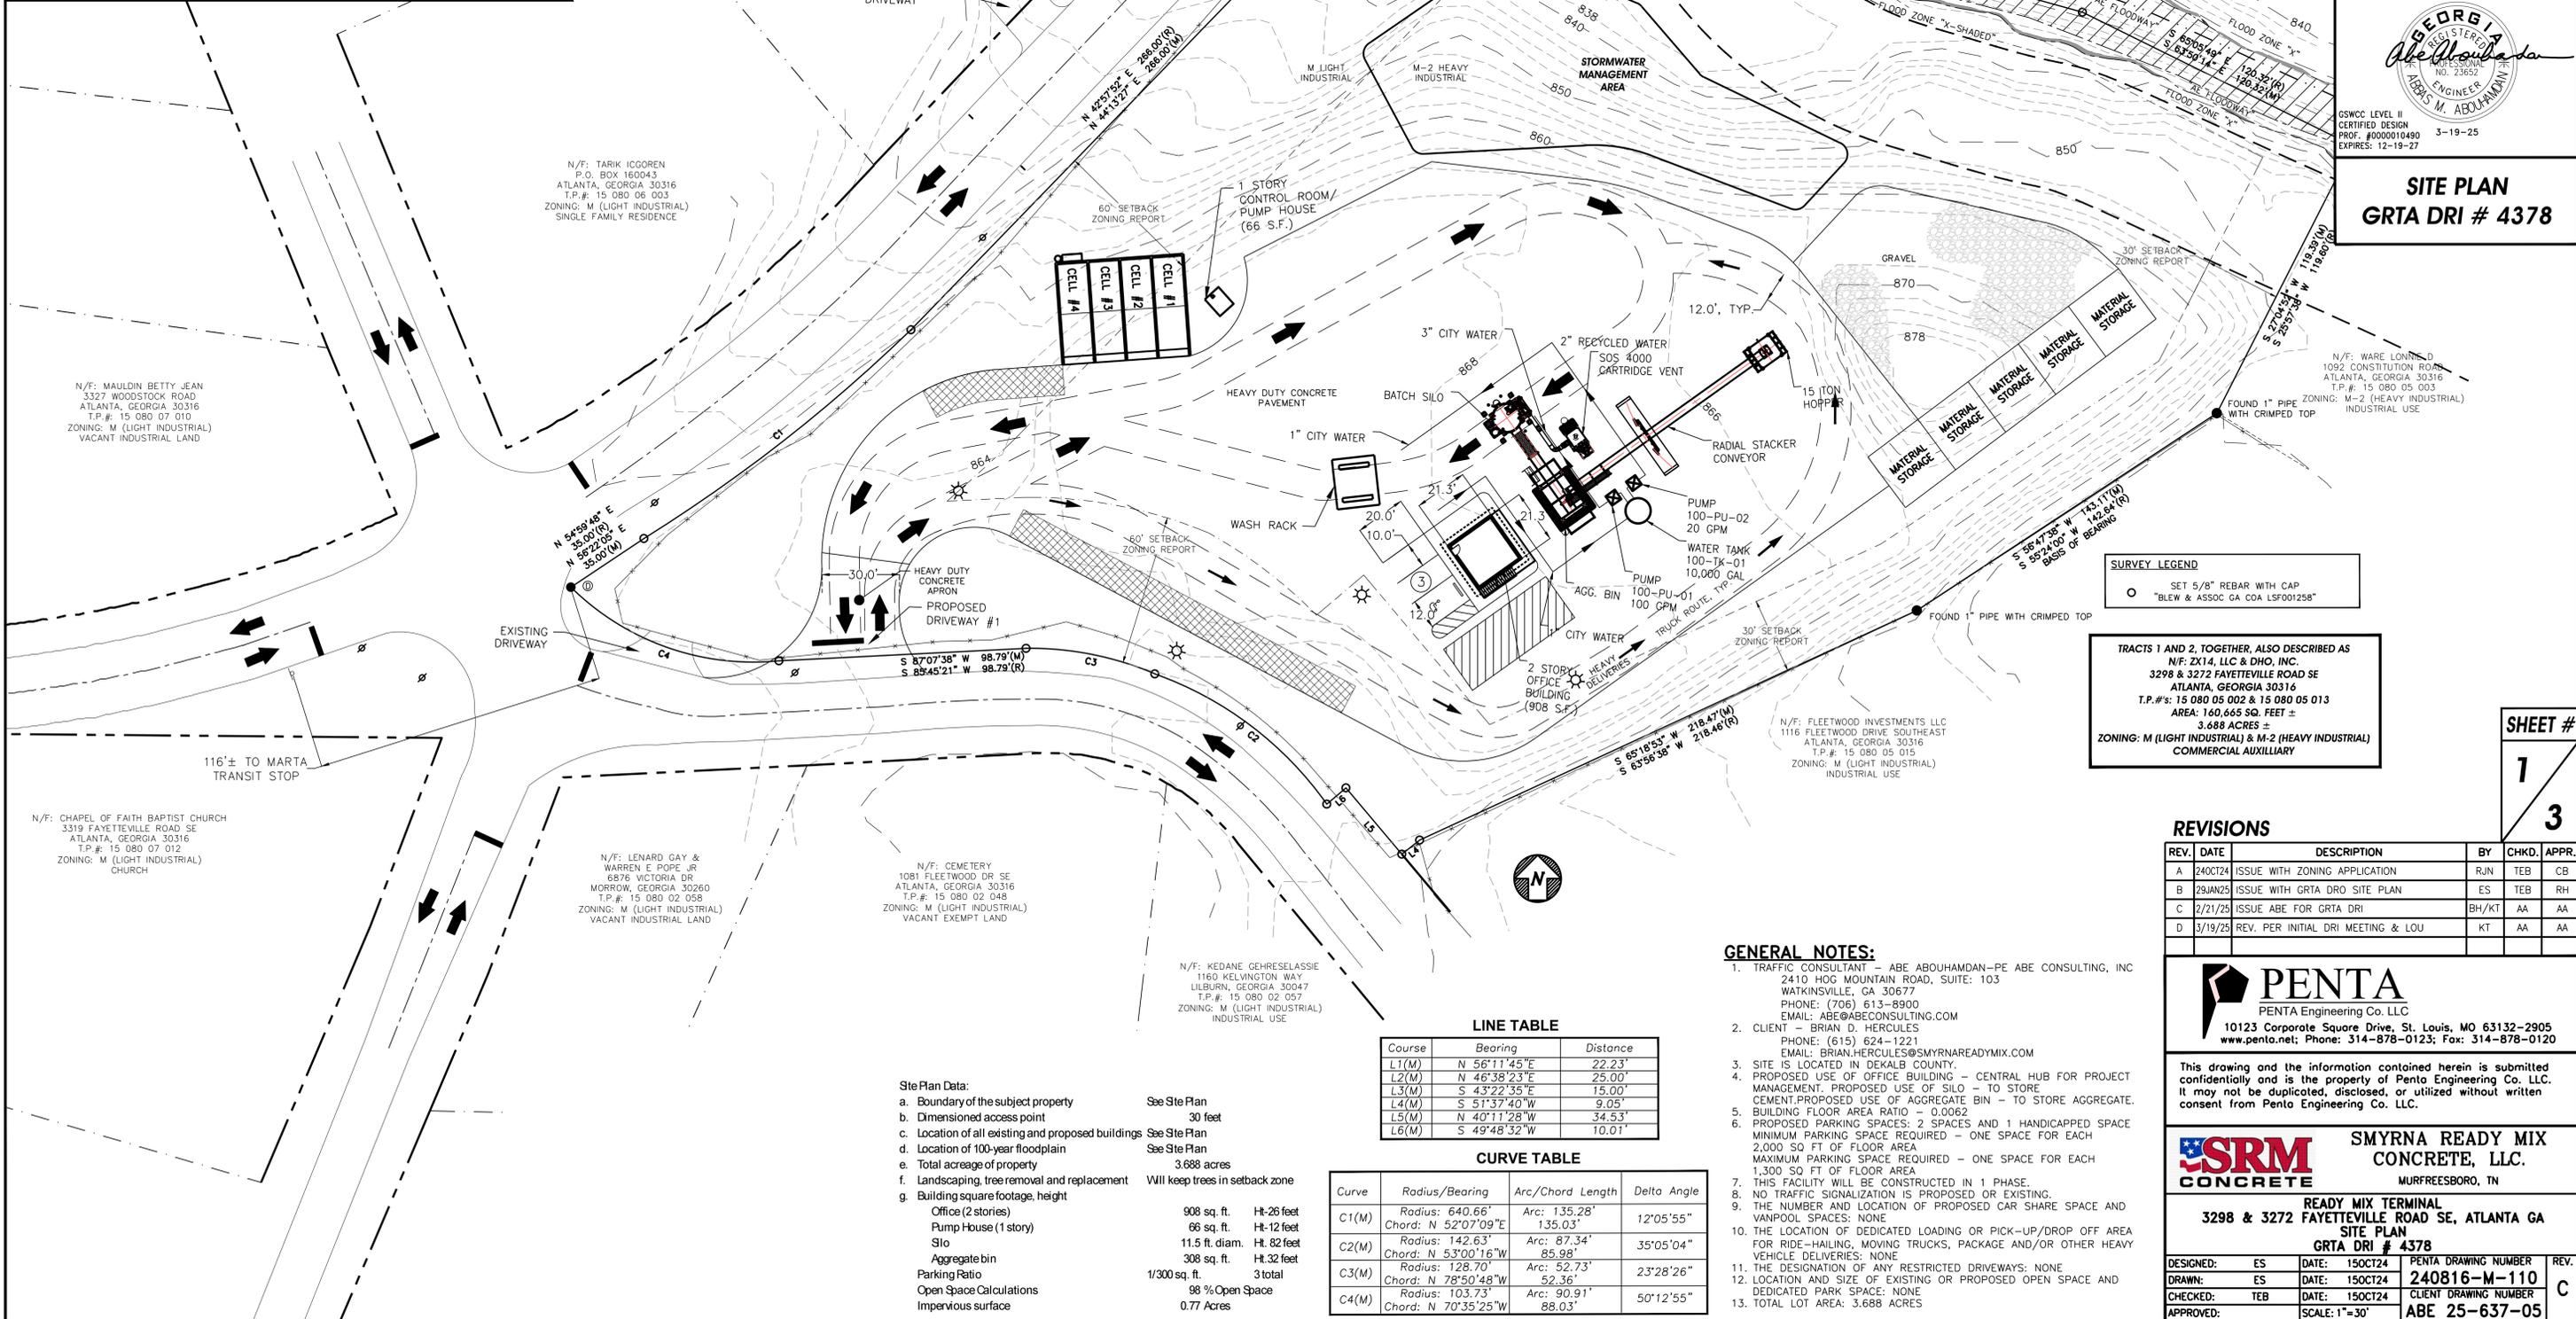

**SURVEY LEGEND**

○	SET 5/8" REBAR WITH CAP
○	"BLEW & ASSOC GA COA LSF001258"

TRACTS 1 AND 2, TOGETHER, ALSO DESCRIBED AS  
 N/F: ZX14, LLC & DHO, INC.  
 3298 & 3272 FAYETTEVILLE ROAD SE  
 ATLANTA, GEORGIA 30316  
 T.P.#: 15 080 05 002 & 15 080 05 013  
 AREA: 160,665 SQ. FEET ±  
 3.688 ACRES ±  
 ZONING: M (LIGHT INDUSTRIAL) & M-2 (HEAVY INDUSTRIAL)  
 COMMERCIAL AUXILIARY

**SHEET #**  
 1  
 3

**REVISIONS**

REV.	DATE	DESCRIPTION	BY	CHKD.	APPR.
A	2/20/24	ISSUE WITH ZONING APPLICATION	RJN	TEB	CB
B	2/23/25	ISSUE WITH GRTA DRO SITE PLAN	ES	TEB	RH
C	2/21/25	ISSUE ABE FOR GRTA DRI	BH/KT	AA	AA
D	3/19/25	REV. PER INITIAL DRI MEETING & LOU	KT	AA	AA

**PENTA**  
 PENTA Engineering Co. LLC  
 10123 Corporate Square Drive, St. Louis, MO 63132-2905  
 www.pentla.net; Phone: 314-878-0123; Fax: 314-878-0120

This drawing and the information contained herein is submitted confidentially and is the property of Penta Engineering Co. LLC. It may not be duplicated, disclosed, or utilized without written consent from Penta Engineering Co. LLC.

**SRM CONCRETE** SMYRNA READY MIX CONCRETE, LLC. MURFREESBORO, TN

**READY MIX TERMINAL**  
 3298 & 3272 FAYETTEVILLE ROAD SE, ATLANTA GA  
**SITE PLAN**  
 GRTA DRI # 4378

DESIGNED: ES	DATE: 15OCT24	PENTA DRAWING NUMBER	REV.
DRAWN: ES	DATE: 15OCT24	<b>240816-M-110</b>	
CHECKED: TEB	DATE: 15OCT24	CLIENT DRAWING NUMBER	C
APPROVED:	SCALE: 1"=30'	<b>ABE 25-637-05</b>	

**GENERAL NOTES:**

- TRAFFIC CONSULTANT - ABE ABOUHAMAN-PE ABE CONSULTING, INC 2410 HOG MOUNTAIN ROAD, SUITE: 103 WATKINSVILLE, GA 30677 PHONE: (706) 613-8900 EMAIL: ABE@ABECONSULTING.COM
- CLIENT - BRIAN D. HERCULES PHONE: (615) 624-1221 EMAIL: BRIAN.HERCULES@SMYRNAREADYMIX.COM
- SITE IS LOCATED IN DEKALB COUNTY.
- PROPOSED USE OF OFFICE BUILDING - CENTRAL HUB FOR PROJECT MANAGEMENT. PROPOSED USE OF SILO - TO STORE CEMENT. PROPOSED USE OF AGGREGATE BIN - TO STORE AGGREGATE.
- BUILDING FLOOR AREA RATIO - 0.0062
- PROPOSED PARKING SPACES: 2 SPACES AND 1 HANDICAPPED SPACE MINIMUM PARKING SPACE REQUIRED - ONE SPACE FOR EACH 2,000 SQ FT OF FLOOR AREA MAXIMUM PARKING SPACE REQUIRED - ONE SPACE FOR EACH 1,300 SQ FT OF FLOOR AREA
- THIS FACILITY WILL BE CONSTRUCTED IN 1 PHASE.
- NO TRAFFIC SIGNALIZATION IS PROPOSED OR EXISTING.
- THE NUMBER AND LOCATION OF PROPOSED CAR SHARE SPACE AND VANPOOL SPACES: NONE
- THE LOCATION OF DEDICATED LOADING OR PICK-UP/DROP OFF AREA FOR RIDE-HAILING, MOVING TRUCKS, PACKAGE AND/OR OTHER HEAVY VEHICLE DELIVERIES: NONE
- THE DESIGNATION OF ANY RESTRICTED DRIVEWAYS: NONE
- LOCATION AND SIZE OF EXISTING OR PROPOSED OPEN SPACE AND DEDICATED PARK SPACE: NONE
- TOTAL LOT AREA: 3.688 ACRES

**LINE TABLE**

Course	Bearing	Distance
L1(M)	N 56°11'45"E	22.23'
L2(M)	N 46°38'23"E	25.00'
L3(M)	S 43°22'35"E	15.00'
L4(M)	S 51°37'40"W	9.05'
L5(M)	N 40°11'28"W	34.53'
L6(M)	S 49°48'32"W	10.01'


**CURVE TABLE**

Curve	Radius/Bearing	Arc/Chord Length	Delta Angle
C1(M)	Radius: 640.66' Chord: N 52°07'09"E	Arc: 135.28' 135.03'	12°05'55"
C2(M)	Radius: 142.63' Chord: N 53°00'16"W	Arc: 87.34' 85.98'	35°05'04"
C3(M)	Radius: 128.70' Chord: N 78°50'48"W	Arc: 52.73' 52.36'	23°28'26"
C4(M)	Radius: 103.73' Chord: N 70°35'25"W	Arc: 90.91' 88.03'	50°12'55"

**Site Plan Data:**


- |  |                                 |
|--|---------------------------------|
| a. Boundary of the subject property                | See Site Plan                   |
| b. Dimensioned access point                        | 30 feet                         |
| c. Location of all existing and proposed buildings | See Site Plan                   |
| d. Location of 100-year floodplain                 | See Site Plan                   |
| e. Total acreage of property                       | 3.688 acres                     |
| f. Landscaping, tree removal and replacement       | Will keep trees in setback zone |
| g. Building square footage, height                 |                                 |
| Office (2 stories)                                 | 908 sq. ft. Ht-26 feet          |
| Pump House (1 story)                               | 66 sq. ft. Ht-12 feet           |
| Silo   | 11.5 ft. diam. Ht. 82 feet      |
| Aggregate bin                                      | 308 sq. ft. Ht. 32 feet         |
| Parking Ratio                                      | 1/300 sq. ft. 3 total           |
| Open Space Calculations                            | 98 % Open Space                 |
| Impervious surface                                 | 0.77 Acres                      |

Z:\PROJECTS\25-637-05 SRM DEKALB CO DRI TRAFFIC\PROJECT DRAWINGS\DRN\_FAYETTEVILLE RD\_3-20-25.DWG

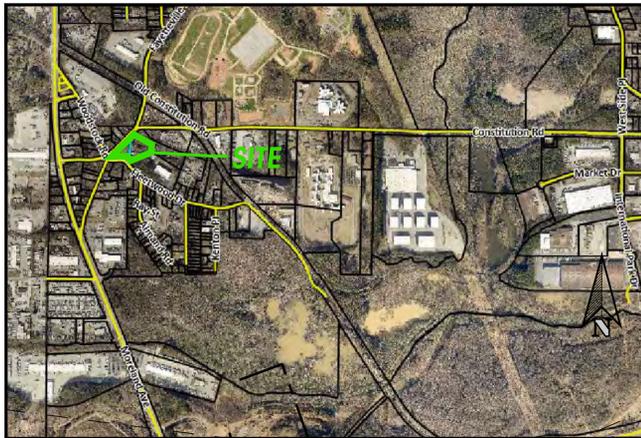

VICINITY MAP

SCALE: N.T.S.

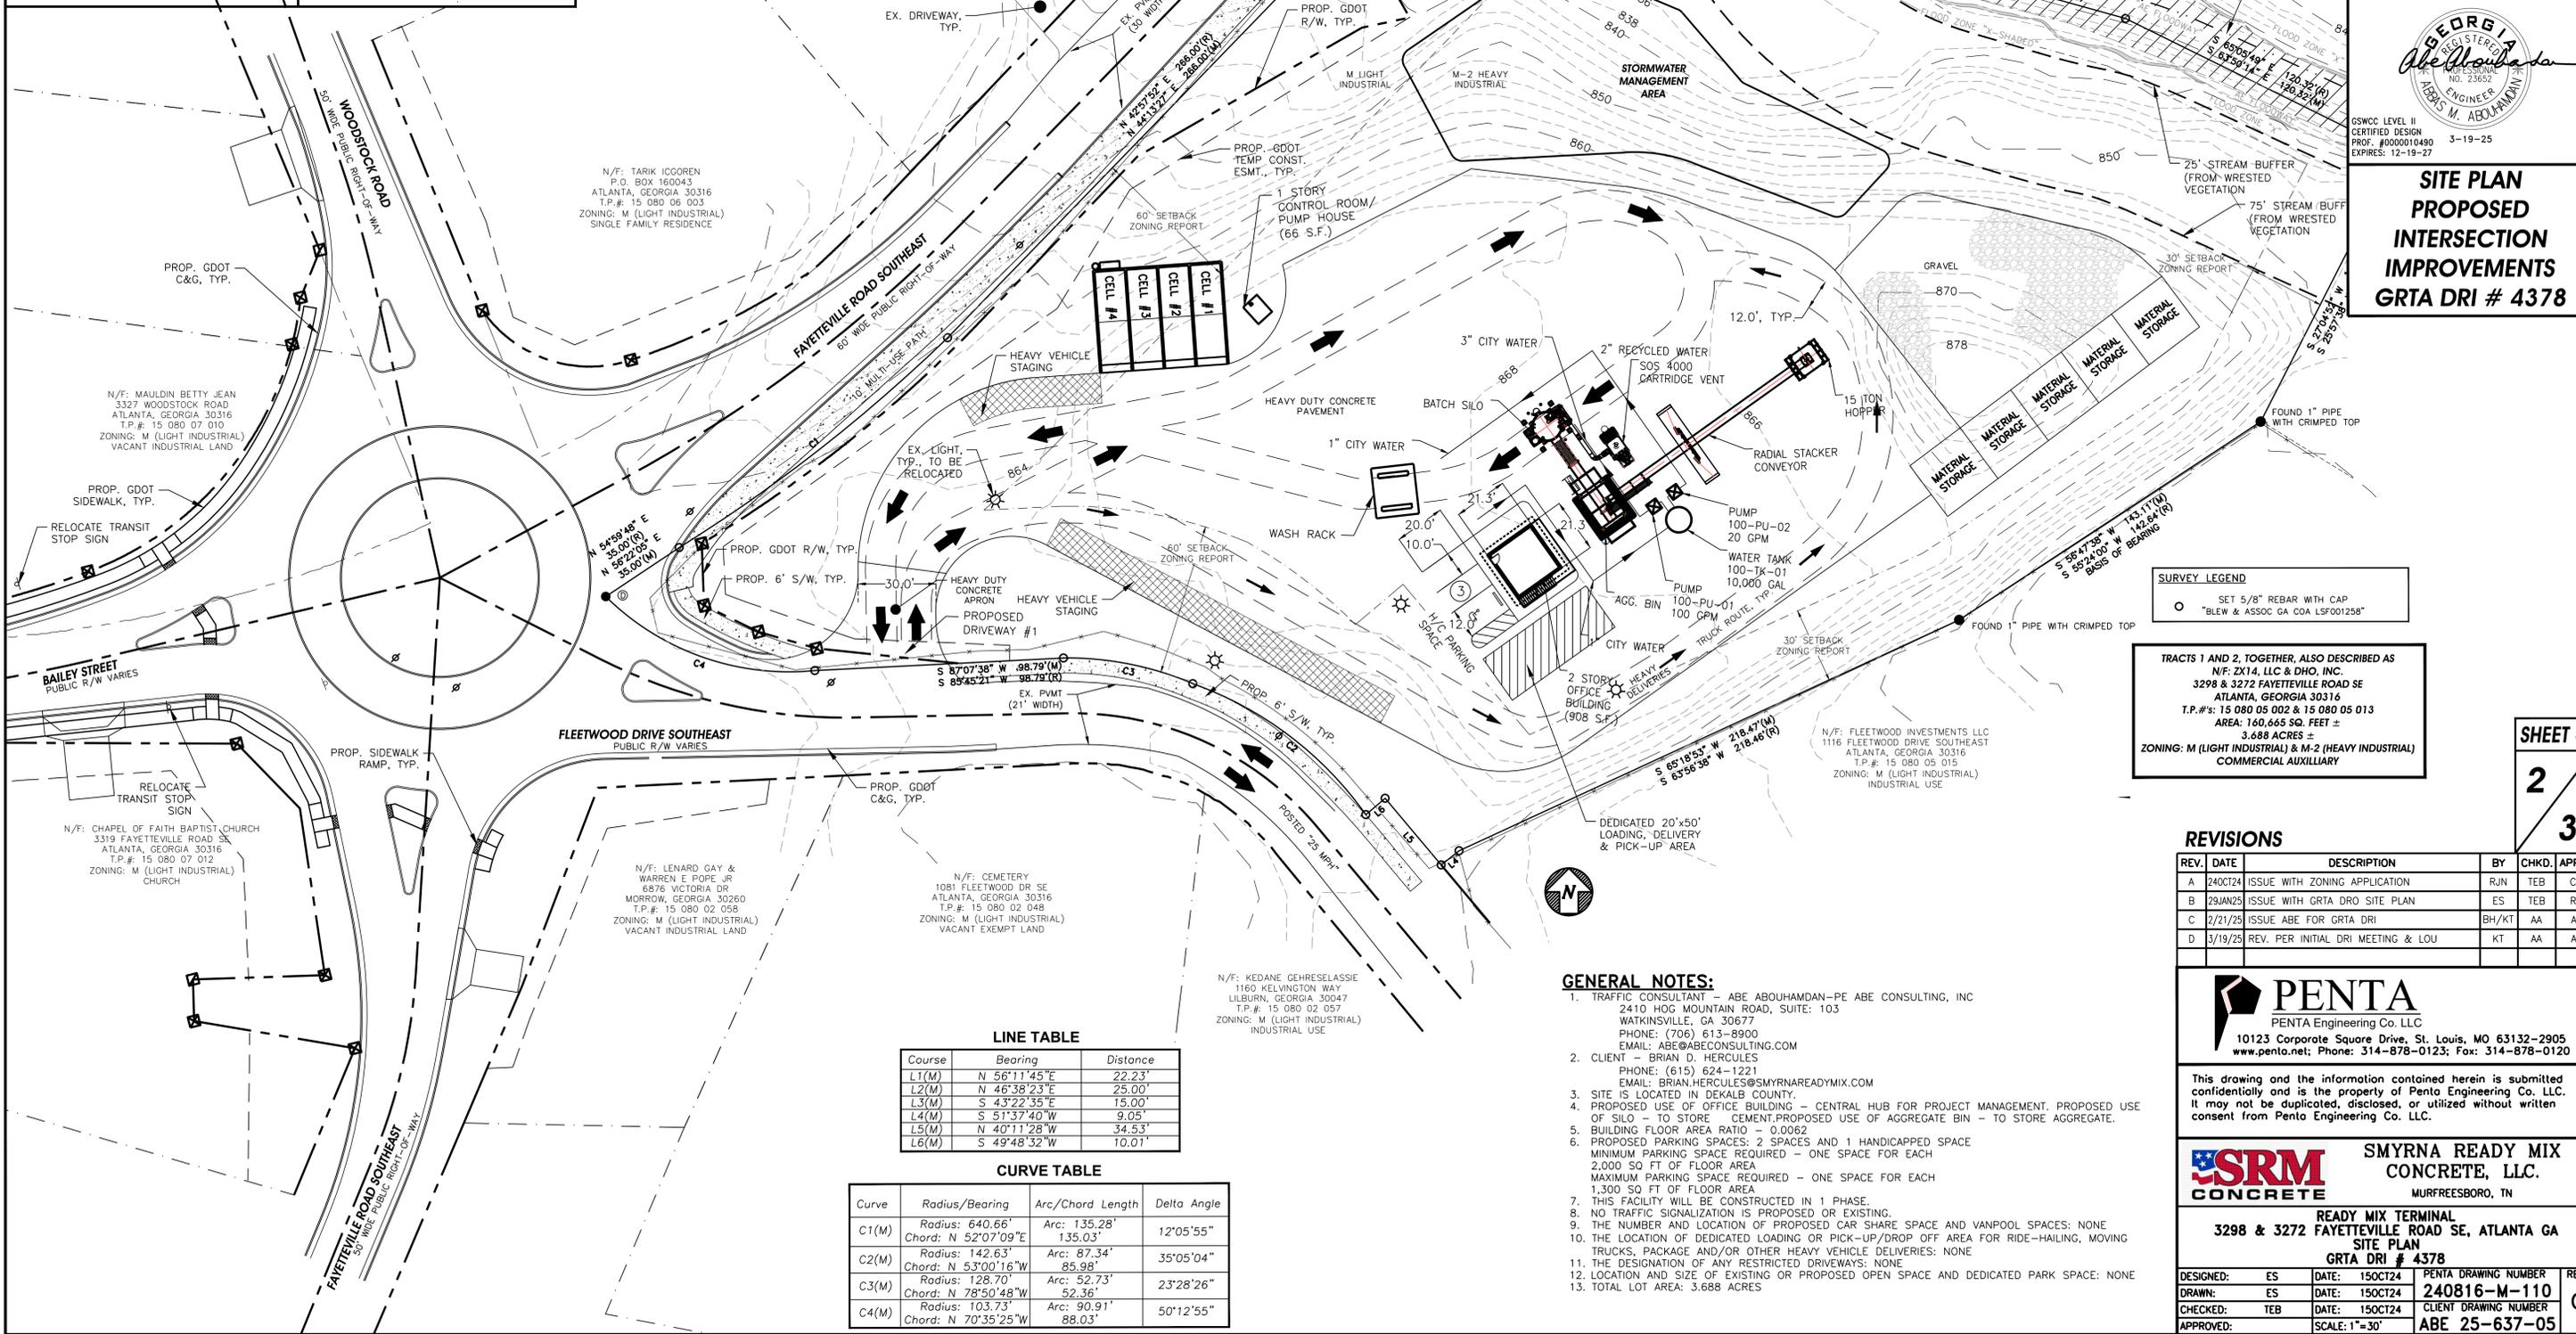

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**BE CONSULTING INC.**

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 SOIL MAPPING & SEPTIC SYSTEMS  
 WETLAND & ENVIRONMENTAL MONITORING

**Georgia Professional Engineers**

ABE ABOUHAMDAN  
 REGISTERED PROFESSIONAL ENGINEER  
 NO. 23652  
 ALEXIS M. ABOUHAMDAN  
 REGISTERED PROFESSIONAL ENGINEER  
 NO. 23653

GSWCC LEVEL II CERTIFIED DESIGN  
 PROF. #0000010490  
 EXPIRES: 12-19-27

**SITE PLAN PROPOSED INTERSECTION IMPROVEMENTS**  
 GRTA DRI # 4378

**SURVEY LEGEND**

- SET 5/8" REBAR WITH CAP "BLEW & ASSOC GA COA LSF001258"

TRACTS 1 AND 2, TOGETHER, ALSO DESCRIBED AS  
 N/F: ZX14, LLC & DHO, INC.  
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 ATLANTA, GEORGIA 30316  
 T.P.#: 15 080 05 002 & 15 080 05 013  
 AREA: 160,665 SQ. FEET ±  
 3.688 ACRES ±  
 ZONING: M (LIGHT INDUSTRIAL) & M-2 (HEAVY INDUSTRIAL)  
 COMMERCIAL AUXILIARY

**REVISIONS**

REV.	DATE	DESCRIPTION	BY	CHKD.	APPR.
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C	2/21/25	ISSUE ABE FOR GRTA DRI	BH/KT	AA	AA
D	3/19/25	REV. PER INITIAL DRI MEETING & LOU	KT	AA	AA

**PENTA**  
 PENTA Engineering Co. LLC  
 10123 Corporate Square Drive, St. Louis, MO 63132-2905  
 www.pentla.net; Phone: 314-878-0123; Fax: 314-878-0120


This drawing and the information contained herein is submitted confidentially and is the property of Penta Engineering Co. LLC. It may not be duplicated, disclosed, or utilized without written consent from Penta Engineering Co. LLC.

**SRM CONCRETE** SMYRNA READY MIX CONCRETE, LLC. MURFREESBORO, TN

**READY MIX TERMINAL**  
 3298 & 3272 FAYETTEVILLE ROAD SE, ATLANTA GA  
 SITE PLAN  
 GRTA DRI # 4378

DESIGNED: ES	DATE: 15OCT24	PENTA DRAWING NUMBER	REV.
DRAWN: ES	DATE: 15OCT24	240816-M-110	
CHECKED: TEB	DATE: 15OCT24	CLIENT DRAWING NUMBER	C
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Z:\PROJECTS\25-637-05 SRM DEKALB CO DR TRAFFIC\PROJECT DRAWINGS\DRM\_FAYETTEVILLE RD\_3-20-25.DWG

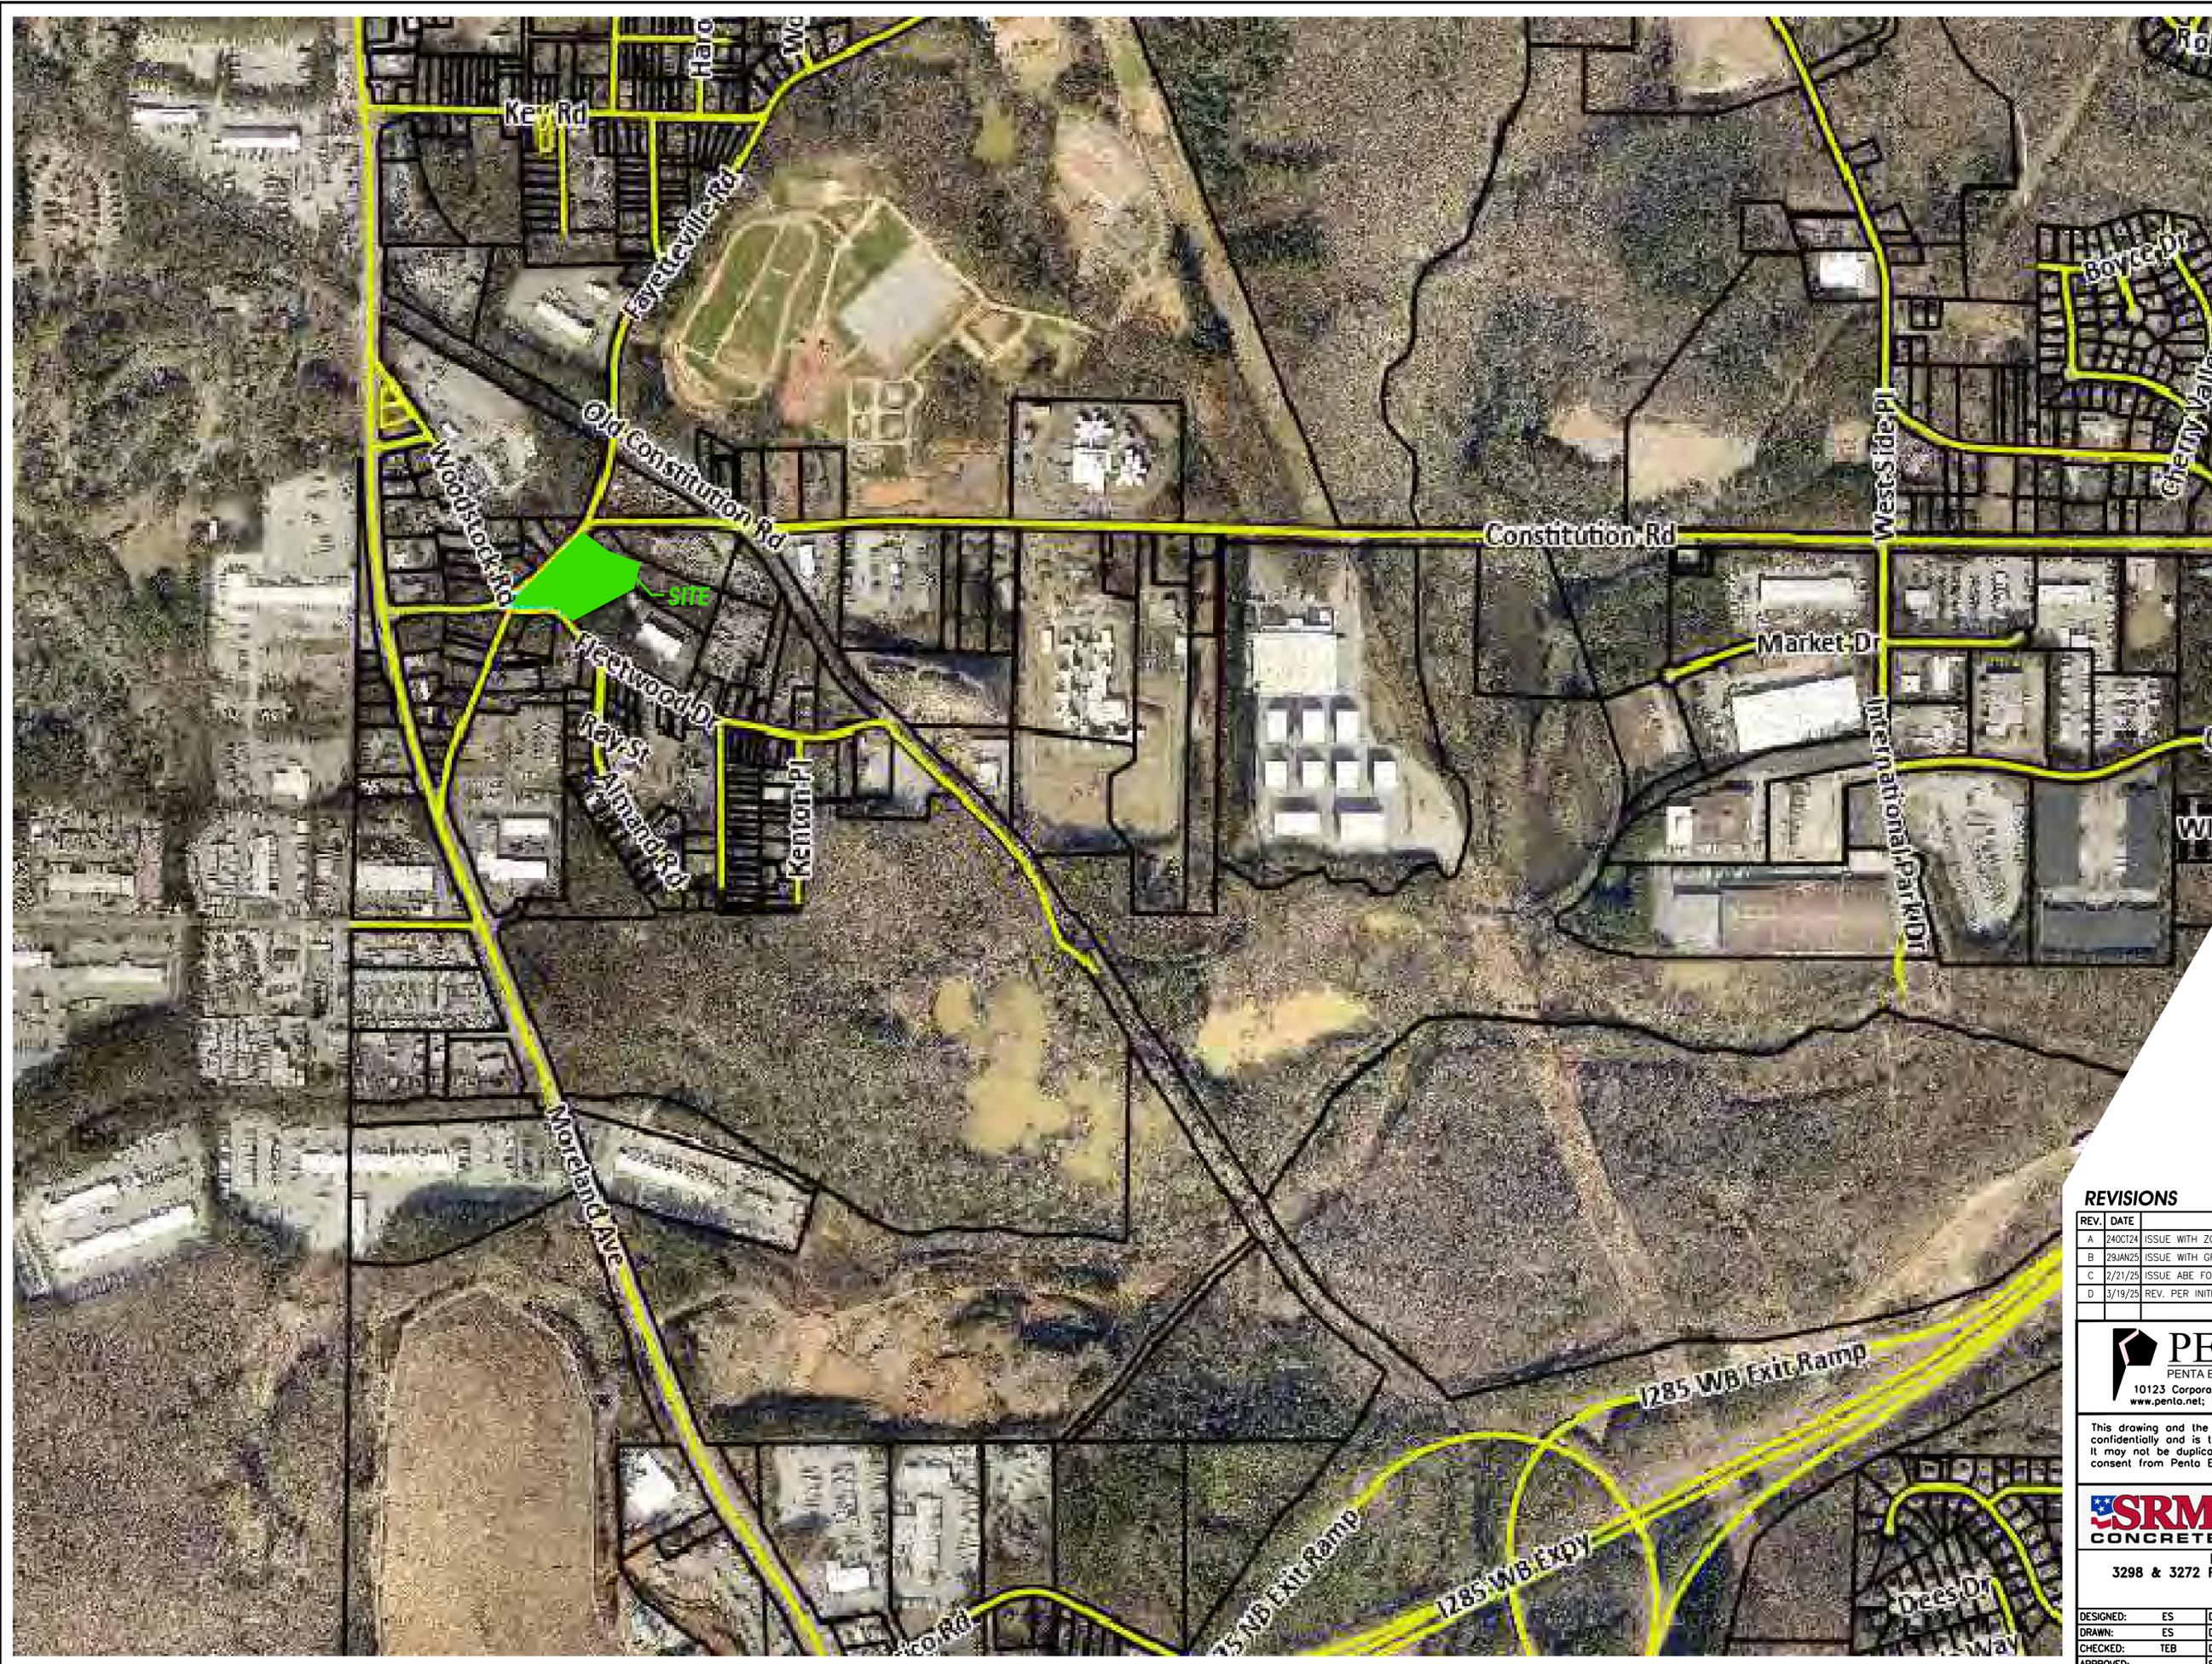

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 SOIL MAPPING & SEPTIC SYSTEMS  
 WETLAND & ENVIRONMENTAL MONITORING



CSWCC LEVEL II  
 CERTIFIED DESIGN  
 PROF. #0000010490 3-19-25  
 EXPIRES: 12-19-27

**SITE AERIAL**



**SHEET #**  
 3 / 3

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A	24OCT24	ISSUE WITH ZONING APPLICATION	RJN	TEB	CB
B	28JUN25	ISSUE WITH GRTA DRO SITE PLAN	ES	TEB	RH
C	2/21/25	ISSUE ABE FOR GRTA DRI	BH/KT	AA	AA
D	3/19/25	REV. PER INITIAL DRI MEETING & LOU	KT	AA	AA

**PENTA**  
 PENTA Engineering Co. LLC  
 10123 Corporate Square Drive, St. Louis, MO 63132-2905  
 www.penta.net; Phone: 314-878-0123; Fax: 314-878-0120

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**SRM CONCRETE** SMYRNA READY MIX CONCRETE, LLC.  
 MURFREESBORO, TN

READY MIX TERMINAL  
 3298 & 3272 FAYETTEVILLE ROAD SE, ATLANTA GA  
 SITE PLAN  
 GRTA DRI # 4378

DESIGNED:	DATE:	PENTA DRAWING NUMBER	REV.
ES	15OCT24	240816-M-110	C
DRAWN:	DATE:	CLIENT DRAWING NUMBER	
ES	15OCT24	240816-M-110	
CHECKED:	DATE:	SCALE:	
TEB	15OCT24	N.T.S	
APPROVED:	DATE:		
TEB	15OCT24		