

REGIONAL REVIEW NOTIFICATION

Atlanta Regional Commission • 229 Peachtree Street NE | Suite 100 | Atlanta, Georgia 30303 • ph: 404.463.3100 fax: 404.463.3205 • atlantaregional.org

DATE: MARCH 5, 2024

TO: Mayor Rusty Paul, City of Sandy Springs

ATTN TO: Helen Owens, Zoning Administrator, City of Sandy Springs FROM: Mike Alexander, COO, Atlanta Regional Commission

The Atlanta Regional Commission (ARC) has received the following proposal and is initiating a Metropolitan River Protection Act regional review to seek comments from potentially impacted jurisdictions and agencies. The ARC requests your comments related to the proposal.

Name of Proposal: 6270 River Overlook Drive

MRPA Code: RC-23-04SS

<u>Description:</u> A regional MRPA review of a proposal to construct an enclosed addition, screen porch, and concrete pad to an existing home on a .68 acre site wholly within the Chattahoochee River Corridor at 6270 River Overlook Drive in the City of Sandy Springs. The total disturbed area of 18,301 SF and impervious area of 11,554 SF are within allowed limits.

<u>Preliminary Finding:</u> ARC staff have initiated a review of an application for a MRPA Certificate for this proposed project in the Chattahoochee River Corridor. ARC's preliminary finding is that the project is consistent with the Chattahoochee River Corridor Plan.

Submitting Local Government: City of Sandy Springs

<u>Date Opened:</u> March 5, 2024 <u>Deadline for Comments:</u> March 15, 2024

Earliest the Regional Review can be Completed:

THE FOLLOWING LOCAL GOVERNMENTS AND AGENCIES ARE RECEIVING NOTICE OF THIS REVIEW:

ATLANTA REGIONAL COMMISSION NATIONAL PARK SERVICE CITY OF ATLANTA GEORGIA DEPARTMENT OF NATURAL RESOURCE GEORGIA CONSERVANCY HISTORIC RIVERLINE CHATTAHOOCHEE RIVERKEEPER
COBB COUNTY

Please submit comments to dshockey@atlantaregional.org. For questions, please contact Donald Shockey at dshockey@atlantaregional.org or (470) 378-1531. If no comments are received by March 15, 2024, ARC will assume that your agency has no input on the subject plan. For more information visit the ARC review website at http://www.atlantaregional.org/land-use/planreviews.

Review materials are attached.

APPLICATION FOR METROPOLITAN RIVER PROTECTION ACT CERTIFICATE

1.	Name of Local G	overnment: JANDY SPRINGS	
2.	Owner(s) of Reco	ord of Property to be Reviewed:	
		LAYNE & DENISE GRATICHY	
		Iress: 6270 RIVER OVERLOOK DR	
	City: SAN	DY SPRINGS State: GA	Zin: 30328
	Contact Pho	ne Numbers (w/Area Code):	
		Phone: 706-271-5259 Fax:	
	Other N	imbers: 678 - 595 - 2215	
3.	Applicant(s) on A	multipopals A monator	
Э.	Applicant(s) of A	Applicant's Agent(s):	
	Mailing Ad	MANE AS ABOUE	
	City	iress:	772
	City:	State:	Zip:
		ne Numbers (w/Area Code):	
	Daytime	Phone: Fax:	
	Other N	umbers:	
5.		of Proposed Use: otion (Attach Legal Description and Vicinity Map):	
	LANDL	, District, Section, County: OT 171, 17th District Fulton Ge	CLNTY
	Subdivision	, Lot, Block, Street and Address, Distance to Neares	t Intersection:
	Size of Deve	lopment (Use as Applicable):	
	Acres:	Inside Corridor: 68	
		Outside Corridor:	
		Total:	
	Lots:	Inside Corridor:	
		Outside Corridor:	
		Total:	
	Units:	Inside Corridor:	
		Outside Corridor:	
		Total:	
	Other Size I	Descriptor (i.e., Length and Width of Easement):	
	Other pro-	Inside Corridor:	
		Outside Corridor:	
		Total:	

	В.	Has any part of the property in this application, or any right-of-way or easement bordering this land, previously received a certificate or any other Chattahoochee Corridor review approval? If "yes", please identify the use(s), the review identification number(s), and the date(s) of the review(s):								
7.	A.	w Will Sewage from this Development be Treated? Septic tank Note: For proposals with septic tanks, the application must include the appropriate local government health department approval for the selected site. Public sewer system								
8.	Sum	Summary of Vulnerability Analysis of Proposed Land or Water Use:								
	_	1 11.4	Total A	creage	Total Acreage	Total Ac	_	Percent	Percent	
	Inera 'atego	•	(or Sq. F	ootage)	(or Sq. Footage) Land Disturbance	(or Sq. F Imperv. S	0,	Land <u>Disturb.</u> (Maximun Parent	Imperv. <u>Surf.</u> ns Shown I heses)	
		•	(or Sq. F		\ I U/	Imperv. S	Surface	<u>Disturb.</u> (Maximun	<u>Surf.</u> ns Shown I	
	atego	•	(or Sq. F		Land Disturbance	Imperv. S	Surface	<u>Disturb.</u> (Maximun Parent	Surf. ns Shown I heses)	
	A B		(or Sq. F		Land Disturbance	Imperv.	Surface	Disturb. (Maximum Parent	Surf. ns Shown I heses)(75) (60)	
	A B C	7C	(or Sq. F	9F	Land Disturbance	Imperv.	9,080	<u>Disturb.</u> (Maximun Parent(90)	Surf. ns Shown I heses) (75) (60)	
	A B C		(or Sq. F	9F 9F	L'and Disturbance	Imperv.	9,080 2,145	Disturb. (Maximum Parent (90) (80) ≤1= (70) 70	Surf. ns Shown I heses) (75) (60) (26) (30)	
	A B C D		(or Sq. F	9F 9F	L'and Disturbance	Imperv.	9,080 2,145	<u>Disturb.</u> (Maximun Parent (90) (80) (5) (70) 70 (50) 50 (30) 30	Surf. ns Shown I heses) (75) (60) (26) (30)	

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9.	
	If "yes", indicate the 100-year floodplain elevation:
	NOTE: For this review, river floodplain is determined from the U.S. Army Corps of
	Engineers' "Floodplain Information - Chattahoochee River, Buford Dam to
	Whitesburg, Georgia", November, 1973 and its Supplement of March, 1982.
	NOTE: All river 100-year floodplain is assigned to the "E" Category; its allowable
	allocations can be combined with those of other "E" land in the review. Also, 100-
	year floodplain cannot be reanalyzed and cannot accept transfers.
	year moodplain cannot be realistyzed and cannot accept transfers.
10	The same of the land and the same of the s
10.	Is any of this land within the 500-year floodplain of the Chattahoochee River? ADO
	If "yes", indicate the 500-year flood plain elevation:
	NOTE: Plan Standards include a 35-foot height limit above the pre-construction
	grade within the 500-year floodplain (includes the 100-year floodplain).
	Adherence to this standard must be noted on the submitted plans (see Part
	2.B.(4) of the Chattahoochee Corridor Plan).
	2004 t) of the Chateanoochee Corridor Trans.
11.	The following is a chaptlist of information required to be attached and of the
11.	The following is a checklist of information required to be attached as part of the
	application. Individual items may be combined.
-	
	ALL APPLICATIONS:
	Description of land in the application and any additional land in the project (attach legal
	description or surveyed boundaries).
	•
	Name, address, and phone number(s) of owner(s) of record of the land in the application.
	(Space provided on this form)
`	Space provided on this form)
,	William and a full and
	Written consent of all owners to this application. (Space provided on this form)
1	Name, address, and phone number(s) of applicant or applicant's agent. (Space provided
0	n this form)
г	escription of proposed use(s). (Space provided on this form)
	reserreption of proposed disc(s). (Space provided on this form)
-	
Ł	xisting vegetation plan.
P	roposed grading plan.
	1 8 k
C	ertified as builts of all existing level 11 to 1
~	ertified as-builts of all existing land disturbance and impervious surfaces.
A	pproved erosion control plan.
	- -
D	etailed table of land-disturbing activities. (Both on this form and on the plans)
	(Doin on this form and on the plans)

Plat-level plan showing (as applicable): lot boundaries; any other sub-areas; all earner and rights-of -way; 100- and 500-year river floodplains; vulnerability category boundaries; topography; any other information that will clarify the review.											
Documentation on adjustments, if any.											
Cashier's check or money order (for application fee).											
FOR SINGLE-STEP APPLICATIONS (NON-SUBDIVISION): Site plan.											
Land-disturbance plan.											
FOR TWO-STEP SINGLE-FAMILY SUBDIVISION APPLICATIONS ONLY: Concept plan.											
Lot-by-lot and non-lot allocation tables.											
Nam Statigny	12-14-23										
Signature(s) of Owner(s) of Record	Date										
3. I (we), the undersigned, authorize and request review of this a under the provisions of the Metropolitan River Protection Ac		tificate									
Signature(s) of Applicant(s) or Agent(s)	Date										
4. The governing authority of The City of Sandy Spring		requests									
review by the Atlanta Regional Commission of the above-dese Provisions of the Metropolitan River Protection Act.	cribed use under the										
Helen Owens	12/15/2023										
Signature of Chief Elected Official or Official's Designee	Date										

STREET ADDRESS: 6270 RIVER OVERLOOK DRIVE NW, SANDY SPRINGS, GA 30328

ZONING: RD-27 (RESIDENTIAL DETACHED)

MINIMUM LOT AREA:

• SINGLE DETACHED = 27,000 SF MIN • ALL OTHER ALLOWED USES = 10,000 SF MIN

• SINGLE DETACHED = 120 FT MIN

• ALL OTHER ALLOWED USES = 100 FT MIN

• LOT COVERAGE = 30% MAX

CANOPY COVERAGE - RESIDENTIAL = 30% MIN - ALL OTHER USES = 40% MIN

- BUILDING SETBACK: PRIMARY STREET = 60 FT MIN
- SIDE STREET = 30 FT MIN • SIDE: COMMON LOT LINE = 15 FT MIN REAR: COMMON LOT LINE = 40 FT MIN

BUILDING HEIGHT: = 3 STORIES/40 FT MAX

PARKING REQUIRED: = 2 PER PRINCIPAL DWELLING UNIT

- 2. SURVEY INFORMATION TAKEN FROM SURVEYS PERFORMED BY FOOTHILLS LAND SURVEYING INC., DATED
- 3. THIS SITE IS NOT LOCATED WITHIN A SPECIAL HAZARD FLOOD ZONE AS DEFINED BY F.I.R.M. COMMUNITY PANEL NUMBER 13121C0141F DATED SEPTEMBER 18, 2013 FOR UNINCORPORATED FULTON COUNTY, GEORGIA.
- 4. THE HOUSE FOOTPRINT IS PROPOSED AND REPRESENTS THE OUTSIDE EDGE OF THE VENEER. THE FOOTPRINT DOES NOT REPRESENT THE ROOF GUTTER LINE OR THE OUTSIDE EDGE OF THE FOOTINGS.
- 5. THESE DRAWINGS AND THEIR REPRODUCTIONS ARE THE PROPERTY OF THE ENGINEER, AND MAY NOT BE REPRODUCED, PUBLISHED, OR USED IN ANY WAY WITHOUT THE WRITTEN PERMISSION OF THIS ENGINEER.
- 6. THIS PLAN WAS PREPARED FOR PERMIT APPROVAL ONLY. ACTUAL CONSTRUCTION SHOULD BE BASED ON LAYOUT BY A REGISTERED LAND SURVEYOR THAT WILL ENSURE THE STRUCTURE IS BUILT WITHIN THE
- 7. THIS PLAN DOES NOT CONSTITUTE AN APPROVAL OF A RETAINING WALL DESIGN. ANY FUTURE RETAINING WALL DESIGN TO BE SUBMITTED BY STRUCTURAL ENGINEER.
- 8. AFTER THE PERMIT IS ISSUED, CONTACT THE DEPARTMENT OF COMMUNITY DEVELOPMENT AT PORTAL TO SCHEDULE A PRE-CONSTRUCTION MEETING WITH THE SITE INSPECTOR PRIOR TO ANY LAND DISTURBANCE BUILDING CONSTRUCTION, OR DEMOLITION.
- 9. IF THE RESIDENCE IS CONSTRUCTED CLOSER THAN 20 FEET TO ANOTHER RESIDENTIAL STRUCTURE OR OTHER OUTBUILDING LARGER THAN 300 SF, AUTOMATIC SPRINKLERS SHALL BE REQUIRED IN THE KITCHEN AND FUEL FIRED EQUIPMENT ROOM PURSUANT TO THE CITY OF SANDY SPRINGS FIRE ORDNANCE 2006-11-86: CHAPTER 15 HEALTH AND PUBLIC SAFETY, EFFECTIVE NOVEMBER 8, 2006.
- 10. OWNER TO EXECUTE AN AGREEMENT FROM CITY OF SANDY SPRINGS COMMUNITY DEVELOPMENT 10. BEFORE ANY DECK STRUCTURES CAN BE BUILT IN ANY PRIVATE EASEMENTS.
- 11. NON-EXEMPT ACTIVITIES SHALL NOT BE CONDUCTED WITHIN THE 25 OR 50-FOOT UNDISTURBED BUFFERS AS MEASURED FROM THE POINT OF WRESTED VEGETATION WITHOUT FIRST ACQUIRING THE NECESSARY VARIANCES AND PERMITS.
- 12. NO DECKS, PATIOS, OR PERMANENT STRUCTURES PERMITTED IN BUFFERS OR EASEMENTS. THE HOUSE ONSITE IS EXISTING AND WAS CONSTRUCTED OF MATERIALS CONSISTING OF BRICK, ROCK, WOOD.
- 13. WASTE MATERIALS SHALL NOT BE DISCHARGED TO WATERS OF THE STATE. EXCEPT AS AUTHORIZED BY A SECTION 404 PERMIT
- 14. THE ESCAPE OF SEDIMENT FROM THE SITE SHALL BE PREVENTED BY THE INSTALLATION OF EROSION AND SEDIMENT CONTROL MEASURES AND PRACTICES PRIOR TO LAND DISTURBING ACTIVITIES.
- 15. EROSION AND SEDIMENT CONTROL MEASURES SHALL BE MAINTAINED AT ALL TIMES. IF FULL IMPLEMENTATION OF THE APPROVED PLAN DOES NOT PROVIDE FOR EFFECTIVE EROSION CONTROL, ADDITIONAL EROSION AND SEDIMENT CONTROL MEASURES SHALL BE IMPLEMENTED TO CONTROL OR TREAT THE SEDIMENT SOURCE.
- 16. ANY DISTURBED AREA LEFT EXPOSED FOR A PERIOD GREATER THAN 14 DAYS SHALL BE STABILIZED WITH MULCH OR TEMPORARY SEEDING.

UTILITY AND OTHER STRUCTURES REQUIREMENTS:

- 1. PROVIDE LOCATION OF EXISTING SANITARY SEWER LATERAL AND NOTE THAT IT IS TO BE RE-USED. IF A CLEANOUT DOES NOT EXIST IN ACCORDANCE WITH FULTON COUNTY STANDARD DRAWING NUMBER 711, SHOW ON PLAN WHERE ONE IS REQUIRED.
- SEE SHEET C-1 2. PROVIDE SANITARY SEWER LINE FROM CLEANOUT TO HOUSE.
- SEE SHEET C-1
- 3. PROVIDE LOCATION OF EXISTING WATER METER AND NOTE THAT IT IS TO BE RE-USED.
- SEE SHEET C-1 4. PROVIDE WATER LINE FROM CLEANOUT TO HOUSE.
- SEE SHEET C-1 5. IF A POOL IS PROPOSED, THE LOCATION OF THE POOL MUST BE SHOWN ON THE PLAN. PROVIDE DIMENSIONS RELATING THE POOL TO THE HOUSE, OTHER STRUCTURES, AND THE PROPERTY LINES. (NOTE: A POOL PERMIT WILL BE REQUIRED PRIOR TO SFSP APPROVAL. SEE POOL PERMIT CHECKLIST.).
- 6. IF INSTALLATION OF A SEPTIC SYSTEM IS PROPOSED OR REQUIRED (INCLUDING REPLACEMENTS). THE LOCATION OF THE SYSTEM MUST BE SHOWN ON THE PLAN EXACTLY THE SAME AS THE APPROVED PLANS BY THE FULTON COUNTY HEALTH DEPARTMENT. PROVIDE DIMENSIONS RELATING THE SEPTIC TANK, FIELD LINES, DOSING TANKS (IF APPLICABLE), ETC. TO THE HOUSE, OTHER STRUCTURES AND THE PROPERTY LINES.
- HEIGHTS OF ALL RETAINING WALLS WITH SPOT ELEVATIONS ALONG WALL AT TOP AND BOTTOM. WALL HEIGHTS BETWEEN 4 AND 6 FEET WILL REQUIRE AN EXECUTED OWNER CERTIFICATION / INDEMNIFICATION FOR RETAINING WALLS. FOR WALL HEIGHTS 6 FEET AND OVER, PLANS MUST BEAR A STATE OF GEORGIA PROFESSIONAL ENGINEER SEAL SIGNED AND DATED, AND AN EXECUTED ENGINEER CERTIFICATION / INDEMNIFICATION FOR RETAINING WALLS.
- 8. IF A FENCE IS PROPOSED, THE LOCATION OF THE FENCE MUST BE SHOWN ON THE PLAN. PROVIDE DIMENSIONS RELATING THE FENCE TO THE HOUSE, OTHER STRUCTURES, AND THE PROPERTY LINES. (NOTE: A FENCE PERMIT MAY BE REQUIRED PRIOR TO SFSP APPROVAL).


TREE REQUIREMENTS:

SEE EX TREE LOCATIONS IN RELATION TO DISTURBED AREA ON SHEET C-3.

24 HOUR EMERGENCY CONTACT: BRANT GOODMAN 678-427-8466 CITY OF SANDY SPRINGS CONSTRUCTION DOCUMENTS FOR:

6270 RIVER OVERLOOK DRIVE NW

LAND LOT 171 DISTRICT 17 CITY OF SANDY SPRINGS, FULTON COUNTY, GEORGIA

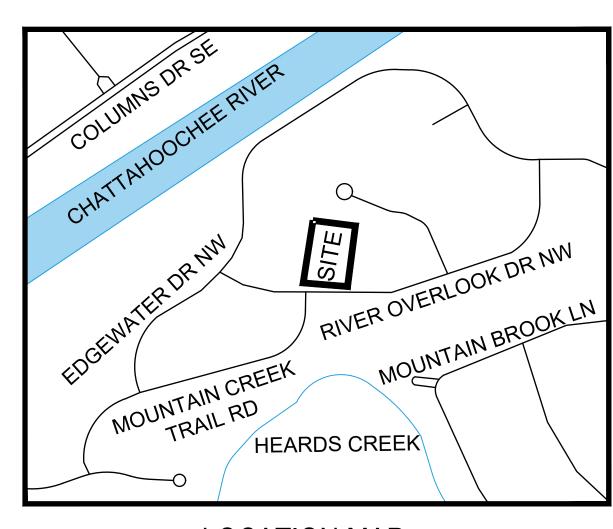

LOCATION MAP

lational Flood Hazard Layer FIRMette Future Conditions 1% Annu Change Flood Hazard Zone Unmapped

STORMWATER REQUIREMENTS:

- ARC APPROVAL, IF REQUIRED. N/A
- 2. LOCATION OF ANY CITY OF SANDY SPRINGS TRIBUTARY BUFFERS, OR STATE WATER BUFFERS, IF
- 3. IF LAND DISTURBANCE IS 1,000 SQUARE FEET OR GREATER, PROVIDE STORMWATER MANAGEMENT FACILITIES THAT WILL PROVIDE STORMWATER STORAGE FOR 1.2 INCHES OF RUNOFF FROM ALL IMPERVIOUS SURFACES WITHIN THE SITE. CONFIGURE FACILITY SO THAT THE DESIGNED DISCHARGE DURATION OF THE WQV EXCEEDS 24 HOURS. VOIDS WITHIN STONE INFILTRATION TRENCHES OR SIMILAR SHALL BE CONSIDERED TO BE 40% OF STONE VOLUME. SHOW ON SITE PLAN THE LAYOUT AND DETAILS OF THE STORMWATER MANAGEMENT FACILITIES. PROVIDE SUPPORTING CALCULATIONS
- 4. WHERE EXISTING RUNOFF LEAVES THE SITE IN A SHEET FLOW CONDITION, RUNOFF SHALL LEAVE THE SITE IN A SHEET FLOW CONDITION AFTER DEVELOPMENT.
- 5. PROVIDE CALCULATIONS FOR WATER QUALITY.

CONSTRUCTION NARRATIVE:

THE PROPOSED PLAN CALLS FOR THE CONSTRUCTION OF A

BMP'S ARE TO REMAIN IN PLACE UNTIL THE SITE IS 100%

NEW ADDITION TO EXISTING HOUSE AND A SCREENED

COVERED PORCH, CONFORMING TO ZONING RD-27. ALL

- PROVIDE TEST DATA TO INSURE THAT THE SOIL UNDERNEATH ALL WATER QUALITY DEVICES USING INFILTRATION HAS A MINIMUM 0.5 INCHES PER HOUR INFILTRATION RATE.
- 7. INFILTRATION TYPE BMPS SHOULD BE A MINIMUM OF 10 FEET AWAY FROM PROPERTY LINES AND/OR FOUNDATIONS AND A MINIMUM OF 20 FEET AWAY FROM SEPTIC SYSTEMS. SUBJECT TO FULTON COUNTY HEALTH DEPARTMENT APPROVAL.
- 8. THE MODIFIED TAFT METHOD IS NOT ACCEPTABLE TO DETERMINE INFILTRATION RATES. A PERCOLATION TEST MAY BE USED TO OBTAIN INFILTRATION RATES PROVIDED IT IS PERFORMED USING THE "PORCHET METHOD".
- 9. PROVIDE A GPS (GEORGIA STATE PLANE ZONE WEST) COORDINATE FOR EACH WATER QUALITY BMP ON THE SITE PLAN.

CITY OF SANDY SPRINGS NOTES:

- 1. THIS SITE IS APPROXIMATELY 741 FT FROM THE CHATTAHOOCHEE RIVER. THEREFORE,
- THIS PROPERTY IS INSIDE THE 2000 FT CORRIDOR. 2. THIS PROPERTY IS NOT LOCATED IN ANY OVERLAY DISTRICT
- 3. THERE IS AN EXISTING STRUCTURE ON SITE THAT WILL BE DEMOLISHED (NOTE -
- DEMOLITION PERMITTED UNDER SEPARATE PERMIT)
- 4. BUILDING HEIGHT SHALL NOT EXCEED 3 STORIES/40 FT 5. NEW WALL HEIGHTS BETWEEN 4 AND 6 FT WILL REQUIRE A WALL INDEMNIFICATION AGREEMENT FROM THE OWNER/BUILDER OR PLANS BEARING A PROFESSIONAL SEAL AND SIGNATURE OF AN ENGINEER HAVING REGISTRATION ON THE STATE OF GEORGIA. FOR WALL HEIGHTS 6 FT AND OVER, RETAINING WALL DESIGN REQUIRED, PLANS MUST BEAR A PROFESSIONAL SEAL AND SIGNATURE OF AN ENGINEER HAVING REGISTRATION IN GEORGIA,
- 6. WHERE EXISTING RUNOFF LEAVES THE SITE IN A SHEET FLOW CONDITION. RUNOFF SHALL LEAVE THE SITE IN A SHEET FLOW CONDITION AFTER DEVELOPMENT. TOTAL SITE AREA = 0.68 ACRES TOTAL
- PROPOSED IMPERVIOUS AREA = 0.01 ACRES 7. ACCESSORY STRUCTURES MAY BE LOCATED IN REAR AND SIDE YARDS BUT SHALL NOT BE LOCATED WITHIN A MINIMUM YARD (I.E. THE SIDE AND REAR YARD SETBACKS). ACCESSORY STRUCTURES INCLUDE BUT ARE NOT LIMITED TO HEATING AND AIR CONDITIONING UNITS AND/OR PADS.

PLAN REQUIREMENTS:

1. MAXIMUM SHEET SIZE SHALL BE 36" x 48" (24" x 36" PREFERRED) (ALL LETTERING SHALL BE READABLE).

PROPOSED PLAN SET ON 24" X 36" PAPER

2. PROJECT NAME AND ADDRESS, SUBDIVISION NAME AND LOT NUMBER (IF APPLICABLE). LAND 6270 RIVER OVERLOOK DRIVE, SANDY SPRINGS, GA 30328, LAND LOT 171, 17TH DISTRICT,

ZONING RD-27

BELMONT WAYNE AND DENISE GRATIGNY, 6270 RIVER OVERLOOK DRIVE, SANDY SPRINGS GA 30328 4. NAME, TELEPHONE NUMBER, AND GSWCC LEVEL 1A CERTIFICATION NUMBER OF A 24-HOUR

CONTACT.

BRANT GOODMAN 678-427-8466 5. DESIGN FIRM NAME/ADDRESS/PHONE, POINT OF CONTACT AND CONTACT PHONE NUMBER. CRESCENT VIEW ENGINEERING, 211 FRASIER STREET S.E., MARIETTA, GA 30060, 678-324-8410 6. NORTH ARROW, SITE ACREAGE, AND SCALE OF DRAWING (1"=10 to 1"=50").

NORTH ARROW SHOWN ON THIS PAGE, SITE ACREAGE IS 0.68 ACRES, SCALE IS 1" = 20' BOUNDARY INFORMATION INCLUDING BEARINGS AND DISTANCES ALONG ALL PROPERTY LINES

PROVIDE SOURCE.

SHOWN ON SURVEY PER SURVEYOR

RIVER OVERLOOK DRIVE

. LOT BUILDING SETBACK LINES (PER SANDY SPRINGS ZONING ORDINANCE) LABELED WITH

<u>ALL SETBACKS ARE SHOWN ON THIS PLAN PER SANDY SPRINGS RD—27 ZONING</u>

10. NAMES OF ADJOINER'S AND RESPECTIVE ZONINGS. NAMES OF THE ADJOINERS ALONG WITH RESPECTIVE ZONING IS SHOWN ON SHEET C-1 OF

11. LOCATIONS OF ALL EXISTING STRUCTURES (INCLUDING HOUSES, BARNS, SHEDS, LANDSCAPE AND RETAINING WALLS, SANITARY AND STORM DRAINAGE LINES AND STRUCTURES, WATER LINES, NEAREST FIRE HYDRANT, DETENTION PONDS AND STRUCTURES, SEPTIC TANKS AND LINES, POOLS, FENCES, ETC.) WITH DISTANCES TO LOT LINES FOR ALL ABOVE GROUND STRUCTURES. ALL EXISTING DISTANCES ARE SHOWN ON THE SURVEY (S-1) AND ALL PROPOSED DISTANCES

12. PROVIDE EXISTING TOPOGRAPHY INCLUDING APPROPRIATE TREES, ALL EXISTING PIPES WITH

THEIR APPROPRIATE EASEMENTS. PROVIDE SOURCE. EXISTING TOPOGRAPHY AND ALL TREES SHOWN ON SURVEY (S-1). ALL KNOWN PIPES ARE

- SHOWN ON PLAN C-1. 13. LOCATIONS OF ALL PROPOSED STRUCTURES (INCLUDING HOUSES, WALLS, SANITARY, AND STORM DRAINAGE LINES AND STRUCTURES, SEPTIC TANKS AND LINES, POOLS, FENCES, ETC.). SIZE AND TYPE OF CONSTRUCTION SHOULD BE CALLED OUT ON THE PLAN WITH DISTANCES TO LOT LINES FOR ALL ABOVE GROUND STRUCTURES.
- ALL PROPOSED DRAWING STRUCTURES ARE SHOWN ON SHEET C-1 14. HEIGHT OF PROPOSED BUILDINGS AND SQUARE FOOTAGE OF EXISTING AND PROPOSED DWELLING (THE DWELLING MUST MEET THE MINIMUM REQUIREMENTS FOR THE PARCEL'S ZONING DISTRICT).
- 15. LOCATION OF ZONING BUFFERS, ACCESS EASEMENTS, SEWER EASEMENTS, AND DRAINAGE EASEMENTS, ETC.
- APPLICABLE EXISTING AND PROPOSED EASEMENTS AND BUFFERS SHOWN ON SHEET C-1
- 16. LOCATION OF DRIVEWAY (EXISTING AND PROPOSED) AND THE PROPOSED CONSTRUCTION ENTRANCE. DIMENSION FROM ANY IMPROVEMENTS OR THE PROPERTY CORNER. PROPOSED DRIVEWAY APRON(S) MUST BE A MINIMUM OF 10 FEET FROM A CATCH BASIN FIRE HYDRANT, AND THE LOT LINE. DRIVEWAY APRON(S) MUST ALSO BE A MINIMUM OF 25 FEET FROM THE RADIUS RETURN ON CORNER LOTS. EXISTING DRIVEWAY TO REMAIN SHOWN ON SHEET C-1.
- 17. FLOOD PLAIN NOTE AND FLOOD INSURANCE RATE MAP (F.I.R.M) PANEL NUMBER AND EFFECTIVE
- THIS SITE IS NOT LOCATED WITHIN A SPECIAL HAZARD FLOOD ZONE AS DEFINED BY F.I.R.M. COMMUNITY PANEL NUMBER 13121C0141 F DATED SEPTEMBER 18, 2013 FOR UNINCORPORATED FULTON COUNTY, GEORGIA.

IF PROPERTY IS LOCATED IN A FLOOD ZONE AS DETERMINED BY FEMA, A CERTIFICATE OF ELEVATION WILL BE REQUIRED.

PLAN MUST STATE EXISTING AND MINIMUM PROPOSED FINISHED FLOOR ELEVATIONS FOR THE MAIN FLOOR, BASEMENT, AND GARAGE. ELEVATIONS MUST BE AT LEAST 3 FEET ABOVE THE 100-YEAR ELEVATION. THE HOUSE MUST BE AT LEAST 10 FEET (HORIZONTALLY) AWAY FROM THE 100-YEAR LIMIT.

18. PROVIDE A COMPLETE GRADING PLAN SHOWING PROPOSED CONTOURS, PIPES, RETAINING WALLS, ETC.

- SEE SHEET C-1 FOR ALL PROPOSED GRADING AND STRUCTURES. 19. IF THE SITE INCLUDES A STORMWATER DETENTION POND OR A NORMALLY WET POND OR LAKE, SUBMITTAL OF A CERTIFICATE OF ELEVATION WILL BE REQUIRED.
- 20. RETAINING WALLS OVER FOUR FEET IN HEIGHT REQUIRE A SEPARATE RETAINING WALL PERMIT IN ACCORDANCE WITH THE CITY OF SANDY SPRINGS' DEVELOPMENT REGULATIONS SECTION 103-27(D) AND SECTION 103-107.
- DRIVEWAY ENTRANCE TO BE IN ACCORDANCE WITH FULTON COUNTY STANDARD DETAIL 304.
- 22. IF THIS PROPERTY IS IN THE CITY OF SANDY SPRINGS' SIDEWALK NETWORK, PROVIDE A FIVE FOOT SIDEWALK WITH A TWO FOOT GROSS STRIP BETWEEN SIDEWALK AND CURB. PROVIDE CURB AND GUTTER IF NONE EXISTS, OR IF THE EXISTING CURB HEIGHT IF LESS THAN FIVE INCHES.
- 23. TWO DRIVEWAY ENTRANCES ARE ALLOWED ONLY ON SINGLE FAMILY RESIDENTIAL LOTS THAT FRONT ON LOCAL STREETS. THE DRIVEWAYS WILL REQUIRE SIGHT DISTANCE CERTIFICATION IN ACCORDANCE WITH THE CITY OF SANDY SPRINGS' DEVELOPMENT REGULATIONS SECTION <u>N/A</u>

	SHEET LIST							
SHEET NO.	NO. SHEET TITLE							
CV	COVER							
S-1	SURVEY							
D-1	DEMOLITION PLAN							
C-1	SITE PLAN							
C-2	ES&PC PLAN							
C-3 TREE PLAN								
C-4	CONSTRUCTION DETAILS							

"I CERTIFY UNDER THE PENALTY OF LAW THAT THIS PLAN WAS PREPARED AFTER A SITE VISIT TO THE LOCATIONS DESCRIBED HEREIN BY MYSELF OR MY AUTHORIZED AGENT, UNDER MY DIRECT SUPERVISION"



02-21-24

For DE Prepared

DMAN [
1877 ARDMORE

SHE COV




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CVE PI # 24-046

2

SHEET NO.

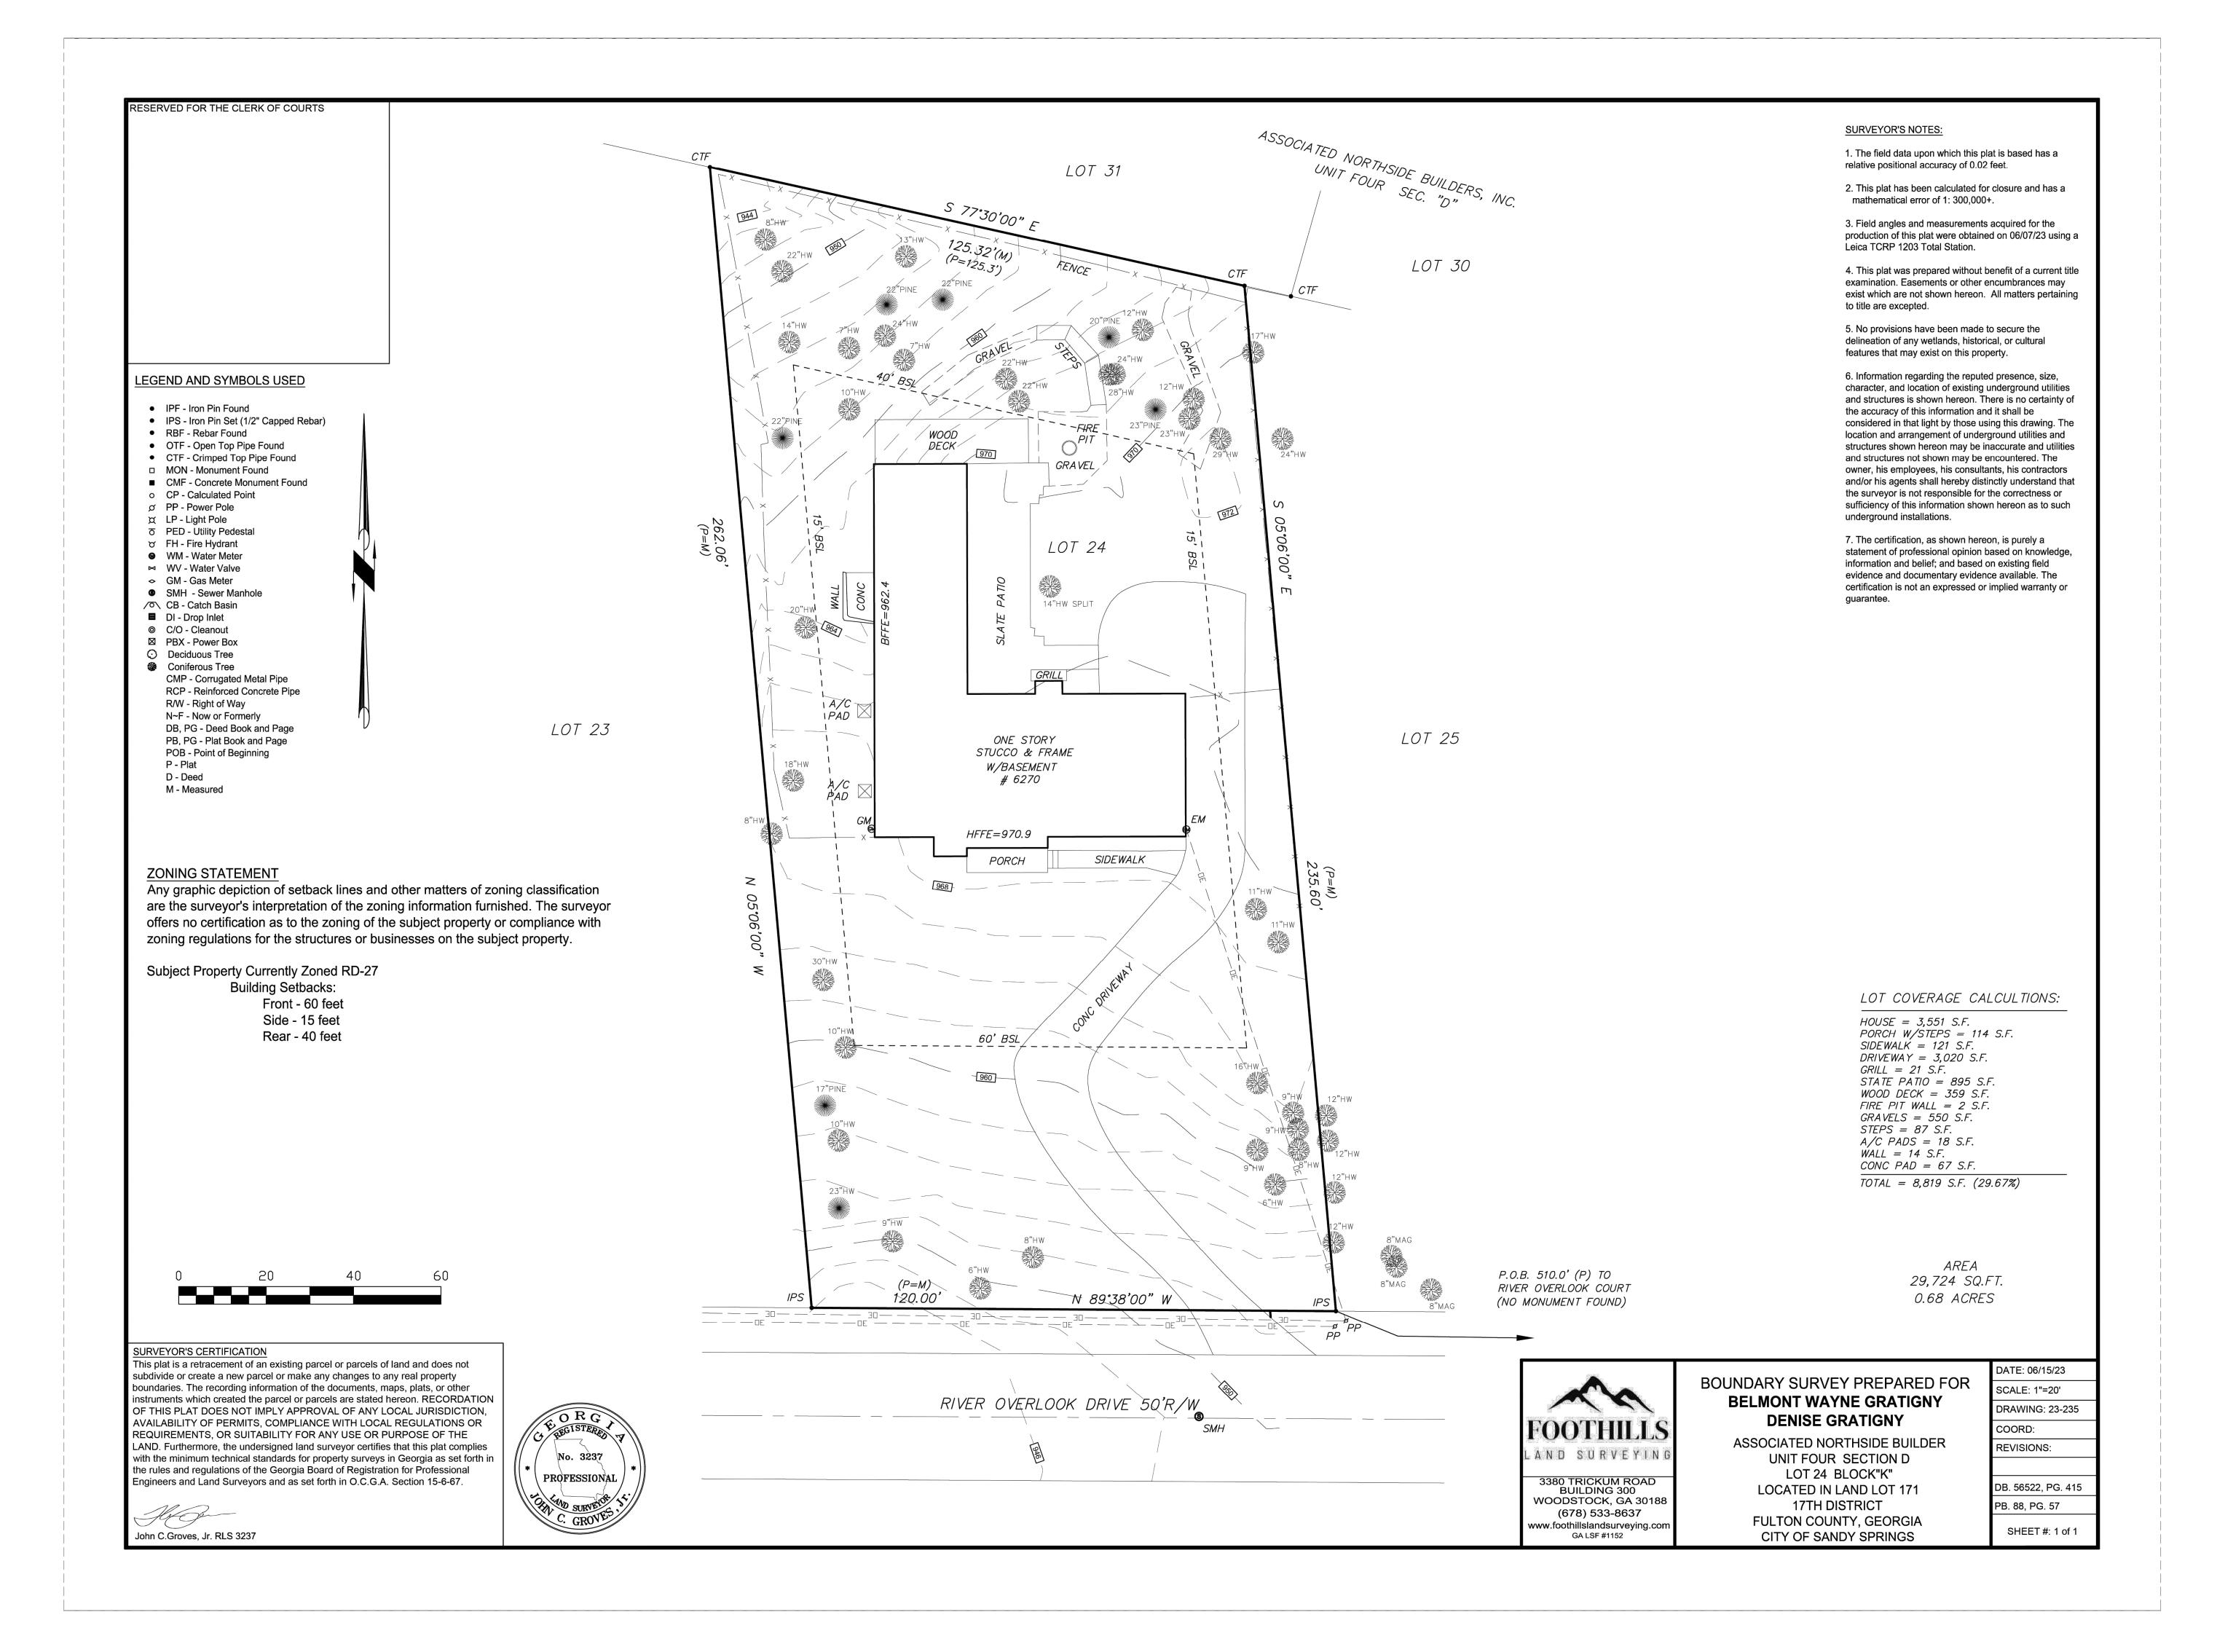

DEMOLITION NOTES:

- 1. THE APPROXIMATE LOCATION OF KNOWN UNDERGROUND UTILITIES HAVE BEEN SHOWN AS PROVIDED BY THE SURVEY. IT SHALL BE THE GENERAL CONTRACTOR'S RESPONSIBILITY TO FIELD VERIFY, LOCATE AND PROTECT ALL UTILITIES ON THE SITE. THE CONTRACTOR SHALL ALSO BE RESPONSIBLE FOR COORDINATING DEMOLITION, RELOCATION AND NEW UTILITY SERVICE WITH THE APPROPRIATE UTILITY. CONTRACTOR SHALL HIRE THEIR OWN UTILITY LOCATOR TO IDENTIFY ALL EXISTING UTILITIES WITHIN THE PROPOSED CONSTRUCTION AREA. ALL EXISTING SANITARY SEWER CONNECTIONS TO BE IDENTIFIED AND CONNECTED TO NEW SANITARY SEWER LINES.
- 2. CONTRACTOR SHALL IMMEDIATELY CONTACT OWNERS REPRESENTATIVE AND ENGINEER IF ANY DISCREPANCIES OR CONFLICTS ARE ENCOUNTERED.
- 3. ALL WORK SHALL COMPLY WITH APPLICABLE FEDERAL, STATE AND LOCAL LAWS, ORDINANCES, STANDARDS OR CODES. ALL NECESSARY LICENSES OR PERMITS SHALL BE OBTAINED BY THE CONTRACTOR AT HIS EXPENSE UNLESS PREVIOUSLY STATED BY OWNER.
- 4. ALL CONSTRUCTION MUST CONFORM TO APPROPRIATE UTILITIES AND COUNTY STANDARDS.
- 5. CONTRACTOR SHALL PROVIDE ALL NECESSARY BARRICADES, SUFFICIENT LIGHTS, SIGNS, AND OTHER TRAFFIC CONTROL METHODS AS MAY BE NECESSARY FOR THE PROTECTION AND SAFETY OF THE PUBLIC. CONTRACTOR SHALL MAINTAIN THESE TRAFFIC CONTROL AND SAFETY METHODS THROUGHOUT CONSTRUCTION OF THIS PROJECT.
- 6. BEFORE STARTING WORK CONTRACTOR SHALL MAKE SUCH EXPLORATIONS AND PROBES AS NECESSARY TO ASCERTAIN ANY ACTIVE UTILITY LINES AND MAKE SURE THESE UTILITIES CAN BE BROKEN OR CHANGED WITHOUT ANY DANGER OR DISRUPTION TO ANY NECESSARY SERVICE.
- 7. FOR ALL ITEMS NOTED TO BE REMOVED REMOVE NOT ONLY THE ABOVE GROUND ELEMENTS, BUT ALL UNDERGROUND ELEMENTS AS WELL INCLUDING BUT NOT NECESSARILY LIMITED TO: FOUNDATIONS, GRAVEL FILLS, TREE ROOTS, OLD PIPE, ETC.
- 8. BACKFILL ALL EXCAVATIONS RESULTING FROM THE DEMOLITION WORK TO MEET THE REQUIREMENTS AND INSTRUCTIONS OF THE PROJECT GEOTECHNICAL ENGINEER.
- 9. DEMOLITION AND SITE PLANS HAVE BEEN PREPARED TO IDENTIFY MAJOR DEMOLITION ITEMS. CONTRACTOR TO PERFORM SITE VISIT PRIOR TO PRICING TO IDENTIFY ALL DEMOLITION ITEMS AS WELL AS IDENTIFYING ITEMS TO SALVAGE FOR OWNER.
- 10. CONTRACTOR SHALL PROTECT ALL EXISTING UTILITIES & ITEMS TO REMAIN.
- 11. CONTRACTOR SHALL BE RESPONSIBLE FOR CONSTRUCTION ACTIVITIES DAMAGE TO EXISTING STRUCTURE DURING CONSTRUCTION.
- 12. CONTRACTOR SHALL COORDINATE WITH OWNER/OWNER REPRESENTATIVE ALL PHASES OF CONSTRUCTION AND UTILITY CONSTRUCTION TO MAKE SURE ACCESS, HOURS OF OPERATION, AND UTILITY INTERRUPTION DO NOT INTERFERE WITH OWNER'S NEEDS.

AFTER THE PERMIT IS ISSUED, CONTACT THE DEPARTMENT OF COMMUNITY DEVELOPMENT AT 770-730-5650 TO SCHEDULE A PRE-CONSTRUCTION MEETING AND CONTACT PER PORTAL WITH THE SITE INSPECTOR PRIOR TO ANY LAND DISTURBANCE, BUILDING CONSTRUCTION OR DEMOLITION

GENERAL DEMOLITION SCOPE:

BE ADVISED THIS IS NOT AN EXHAUSTIVE LIST OF DEMOLITION ITEMS. CONTRACTOR SHALL BECOME FAMILIAR WITH THE SITE AND THE COMPLETE DESIGN INTENT OF THE CONSTRUCTION DOCUMENTS. ANY QUESTIONS, CONCERNS, OR IDEAS CONCERNING THE INTENT OR EXECUTION OF THE DESIGN DOCUMENTS MUST BE BROUGHT TO THE OWNER BEFORE PERFORMING ANY CONSTRUCTION ACTIVITY.

1 REMOVE EXISTING WALL

2 REMOVE EXISTING CONCRETE PAD

3 REMOVE PORTION OF EXISTING DECK

REMOVAL OF DEBRIS OR ITEMS OUTSIDE OF LIMITS OF DISTURBANCE TO BE REMOVED BY HAND OR HAND MACHINERY. REMOVAL WORK IN AREA OF CRITICAL ROOT ZONE OF EXISTING TREES TO BE DONE BY HAND OR HAND MACHINERY

NO TREES REMOVED OR DESTROYED AS A PART OF DEMOLITION



Know what's below. Call before you dig.

PRE-CONSTRUCTION LOT COVERAGE:

EXISTING IMPERIVIOUS AREA	SF
EX. HOUSE	3,551
EX. DRIVEWAY	3,020
EX. PORCH	104
EX. SIDEWALK	121
EX. PATIO	916
EX.WOOD DECK	357
EX. WALL	14
EX. GRAVEL	612
EX. STEPS	97
TOTAL EXISTING IMPERVIOUS AREA	8,792
LOT COVERAGE %	29.58%

SCALE: 1" = 20'

24 HOUR EMERGENCY CONTACT: BRANT GOODMAN 678-427-8466





DE POL Prepared DMAN [

<u>NO</u>

DRIVE OOK District County, Site Plan For:
OVERL
ot 171, 17th Derings, Fulton RIVER
Land Lo

6270 CVE PI # 24-046

SHEET NO.

SITE NOTES:

1. THE SITE CONTAINS: 0.68 ACRES / 29,724 SF TOTAL DISTURBED ACREAGE: 0.02 ACRES

STREET ADDRESS: 6270 RIVER OVERLOOK DRIVE NW, SANDY SPRINGS, GA 30328

ZONING: <u>RD-27 (RESIDENTIAL DETACHED)</u> MINIMUM LOT AREA:

• SINGLE DETACHED = 27,000 SF MIN

ALL OTHER ALLOWED USES = 10,000 SF MIN

• SINGLE DETACHED = 120 FT MIN ALL OTHER ALLOWED USES = 100 FT MIN

LOT COVERAGE = 30% MAX

CANOPY COVERAGE - RESIDENTIAL = 30% MIN

ALL OTHER USES = 40% MIN

- BUILDING SETBACK: PRIMARY STREET = 60 FT MIN
- SIDE STREET = 30 FT MIN
- SIDE: COMMON LOT LINE = 15 FT MIN REAR: COMMON LOT LINE = 40 FT MIN

BUILDING HEIGHT: = 3 STORIES/40 FT MAX

PARKING REQUIRED: = 2 PER PRINCIPAL DWELLING UNIT

- 2. SURVEY INFORMATION TAKEN FROM SURVEYS PERFORMED BY FOOTHILLS LAND SURVEYING INC., DATED 06-15-23
- 3. THIS SITE IS NOT LOCATED WITHIN A SPECIAL HAZARD FLOOD ZONE AS DEFINED BY F.I.R.M. COMMUNITY PANEL NUMBER 13121C0141F DATED SEPTEMBER 18, 2013 FOR UNINCORPORATED FULTON COUNTY, GEORGIA.
- 4. THE HOUSE FOOTPRINT IS PROPOSED AND REPRESENTS THE OUTSIDE EDGE OF THE VENEER. THE FOOTPRINT DOES NOT REPRESENT THE ROOF GUTTER LINE OR THE OUTSIDE EDGE OF THE FOOTINGS.
- 5. THESE DRAWINGS AND THEIR REPRODUCTIONS ARE THE PROPERTY OF THE ENGINEER, AND MAY NOT BE REPRODUCED, PUBLISHED, OR USED IN ANY WAY WITHOUT THE WRITTEN PERMISSION OF THIS ENGINEER.
- 6. THIS PLAN WAS PREPARED FOR PERMIT APPROVAL ONLY. ACTUAL CONSTRUCTION SHOULD BE BASED ON LAYOUT BY A REGISTERED LAND SURVEYOR THAT WILL ENSURE THE STRUCTURE IS BUILT WITHIN THE SETBACK LINES.
- 7. THIS PLAN DOES NOT CONSTITUTE AN APPROVAL OF A RETAINING WALL DESIGN. ANY FUTURE RETAINING WALL DESIGN TO BE SUBMITTED BY STRUCTURAL ENGINEER.
- 8. AFTER THE PERMIT IS ISSUED, CONTACT THE DEPARTMENT OF COMMUNITY DEVELOPMENT AT PORTAL TO SCHEDULE A PRE-CONSTRUCTION MEETING WITH THE SITE INSPECTOR PRIOR TO ANY LAND DISTURBANCE, BUILDING CONSTRUCTION, OR DEMOLITION.
- 9. IF THE RESIDENCE IS CONSTRUCTED CLOSER THAN 20 FEET TO ANOTHER RESIDENTIAL STRUCTURE OR OTHER OUTBUILDING LARGER THAN 300 SF, AUTOMATIC SPRINKLERS SHALL BE REQUIRED IN THE KITCHEN AND FUEL FIRED EQUIPMENT ROOM PURSUANT TO THE CITY OF SANDY SPRINGS FIRE ORDNANCE 2006-11-86: CHAPTER 15 HEALTH AND PUBLIC SAFETY, EFFECTIVE NOVEMBER 8, 2006.
- 10. OWNER TO EXECUTE AN AGREEMENT FROM CITY OF SANDY SPRINGS COMMUNITY DEVELOPMENT 10. BEFORE ANY DECK STRUCTURES CAN BE BUILT IN ANY PRIVATE EASEMENTS.
- 11. NON-EXEMPT ACTIVITIES SHALL NOT BE CONDUCTED WITHIN THE 25 OR 50-FOOT UNDISTURBED BUFFERS AS MEASURED FROM THE POINT OF WRESTED VEGETATION WITHOUT FIRST ACQUIRING THE NECESSARY VARIANCES AND PERMITS.
- 12. NO DECKS, PATIOS, OR PERMANENT STRUCTURES PERMITTED IN BUFFERS OR EASEMENTS. THE HOUSE ONSITE IS EXISTING AND WAS CONSTRUCTED OF MATERIALS CONSISTING OF BRICK, ROCK, WOOD.
- 13. WASTE MATERIALS SHALL NOT BE DISCHARGED TO WATERS OF THE STATE, EXCEPT AS AUTHORIZED BY A SECTION 404 PERMIT.
- 14. THE ESCAPE OF SEDIMENT FROM THE SITE SHALL BE PREVENTED BY THE INSTALLATION OF EROSION AND SEDIMENT CONTROL MEASURES AND PRACTICES PRIOR TO LAND DISTURBING ACTIVITIES.
- 15. EROSION AND SEDIMENT CONTROL MEASURES SHALL BE MAINTAINED AT ALL TIMES. IF FULL IMPLEMENTATION OF THE APPROVED PLAN DOES NOT PROVIDE FOR EFFECTIVE EROSION CONTROL, ADDITIONAL EROSION AND SEDIMENT CONTROL MEASURES SHALL BE IMPLEMENTED TO CONTROL OR TREAT THE SEDIMENT SOURCE.
- 16. ANY DISTURBED AREA LEFT EXPOSED FOR A PERIOD GREATER THAN 14 DAYS SHALL BE STABILIZED WITH MULCH OR TEMPORARY SEEDING.

CITY OF SANDY SPRINGS NOTES:

- 1. THIS SITE IS APPROXIMATELY 741 FT FROM THE CHATTAHOOCHEE RIVER. THEREFORE,
- THIS PROPERTY IS INSIDE THE 2000 FT CORRIDOR.
- 2. THIS PROPERTY IS NOT LOCATED IN ANY OVERLAY DISTRICT 3. THERE IS AN EXISTING STRUCTURE ON SITE THAT WILL BE DEMOLISHED (NOTE -
- DEMOLITION PERMITTED UNDER SEPARATE PERMIT).
- 4. BUILDING HEIGHT SHALL NOT EXCEED 3 STORIES/40 FT 5. NEW WALL HEIGHTS BETWEEN 4 AND 6 FT WILL REQUIRE A WALL INDEMNIFICATION AGREEMENT FROM THE OWNER/BUILDER OR PLANS BEARING A PROFESSIONAL SEAL AND SIGNATURE OF AN ENGINEER HAVING REGISTRATION ON THE STATE OF GEORGIA. FOR WALL HEIGHTS 6 FT AND OVER, RETAINING WALL DESIGN REQUIRED, PLANS MUST BEAR A PROFESSIONAL SEAL AND SIGNATURE OF AN ENGINEER HAVING REGISTRATION IN GEORGIA, BY OTHERS.
- 6. WHERE EXISTING RUNOFF LEAVES THE SITE IN A SHEET FLOW CONDITION, RUNOFF SHALL LEAVE THE SITE IN A SHEET FLOW CONDITION AFTER DEVELOPMENT. TOTAL SITE AREA = 0.68 ACRES TOTAL PROPOSED IMPERVIOUS AREA = 0.01 ACRES
- 7. ACCESSORY STRUCTURES MAY BE LOCATED IN REAR AND SIDE YARDS BUT SHALL NOT BE LOCATED WITHIN A MINIMUM YARD (I.E. THE SIDE AND REAR YARD SETBACKS). ACCESSORY STRUCTURES INCLUDE BUT ARE NOT LIMITED TO HEATING AND AIR CONDITIONING UNITS AND/OR PADS.

POST-CONSTRUCTION LOT COVERAGE:

EXISTING IMPERVIOUS AREAS TO REMAIN	SF
EX. HOUSE	3,551
EX. DRIVEWAY	3,020
EX. PORCH	104
EX. SIDEWALK	121
EX. PATIO	916
EX.WOOD DECK	143
EX. GRAVEL	465
EX. STEPS	97
TOTAL - EXISTING IMPERVIOUS TO REMAIN	8,417
PROPOSED IMPERVIOUS AREA	SF
PROPOSED ADDITION	176
PROPOSED COVERED PORCH	220
PROPOSED WALL	10
PROPOSED WALL	10
PROPOSED PAD	80
PROPOSED PAD	80
PROPOSED PAD	80


Know what's below.

ARC VULNERABILITY CHART:

Category	С	D	Е
Total Area	20,177	6,564	2,983
% Maximum Clearing	70%	50%	30%
Allocated Clearing Area	14,124	3,282	895
% Maximum Impervious	45%	30%	15%
Allocated Impervious Area	9,080	1,969	447
Existing Clearing Area	9,956	2,313	0
Existing Impervious Area	6,784	1,659	0
Proposed Clearing Area	0	872	0
Proposed Impervious Area	0	486	0
Remaining Clearing Area	4,168	97	895
Remaining Impervious Area	9,080	1,483	447

ARC Allocation Table

24 HOUR EMERGENCY CONTACT: BRANT GOODMAN 678-427-8466

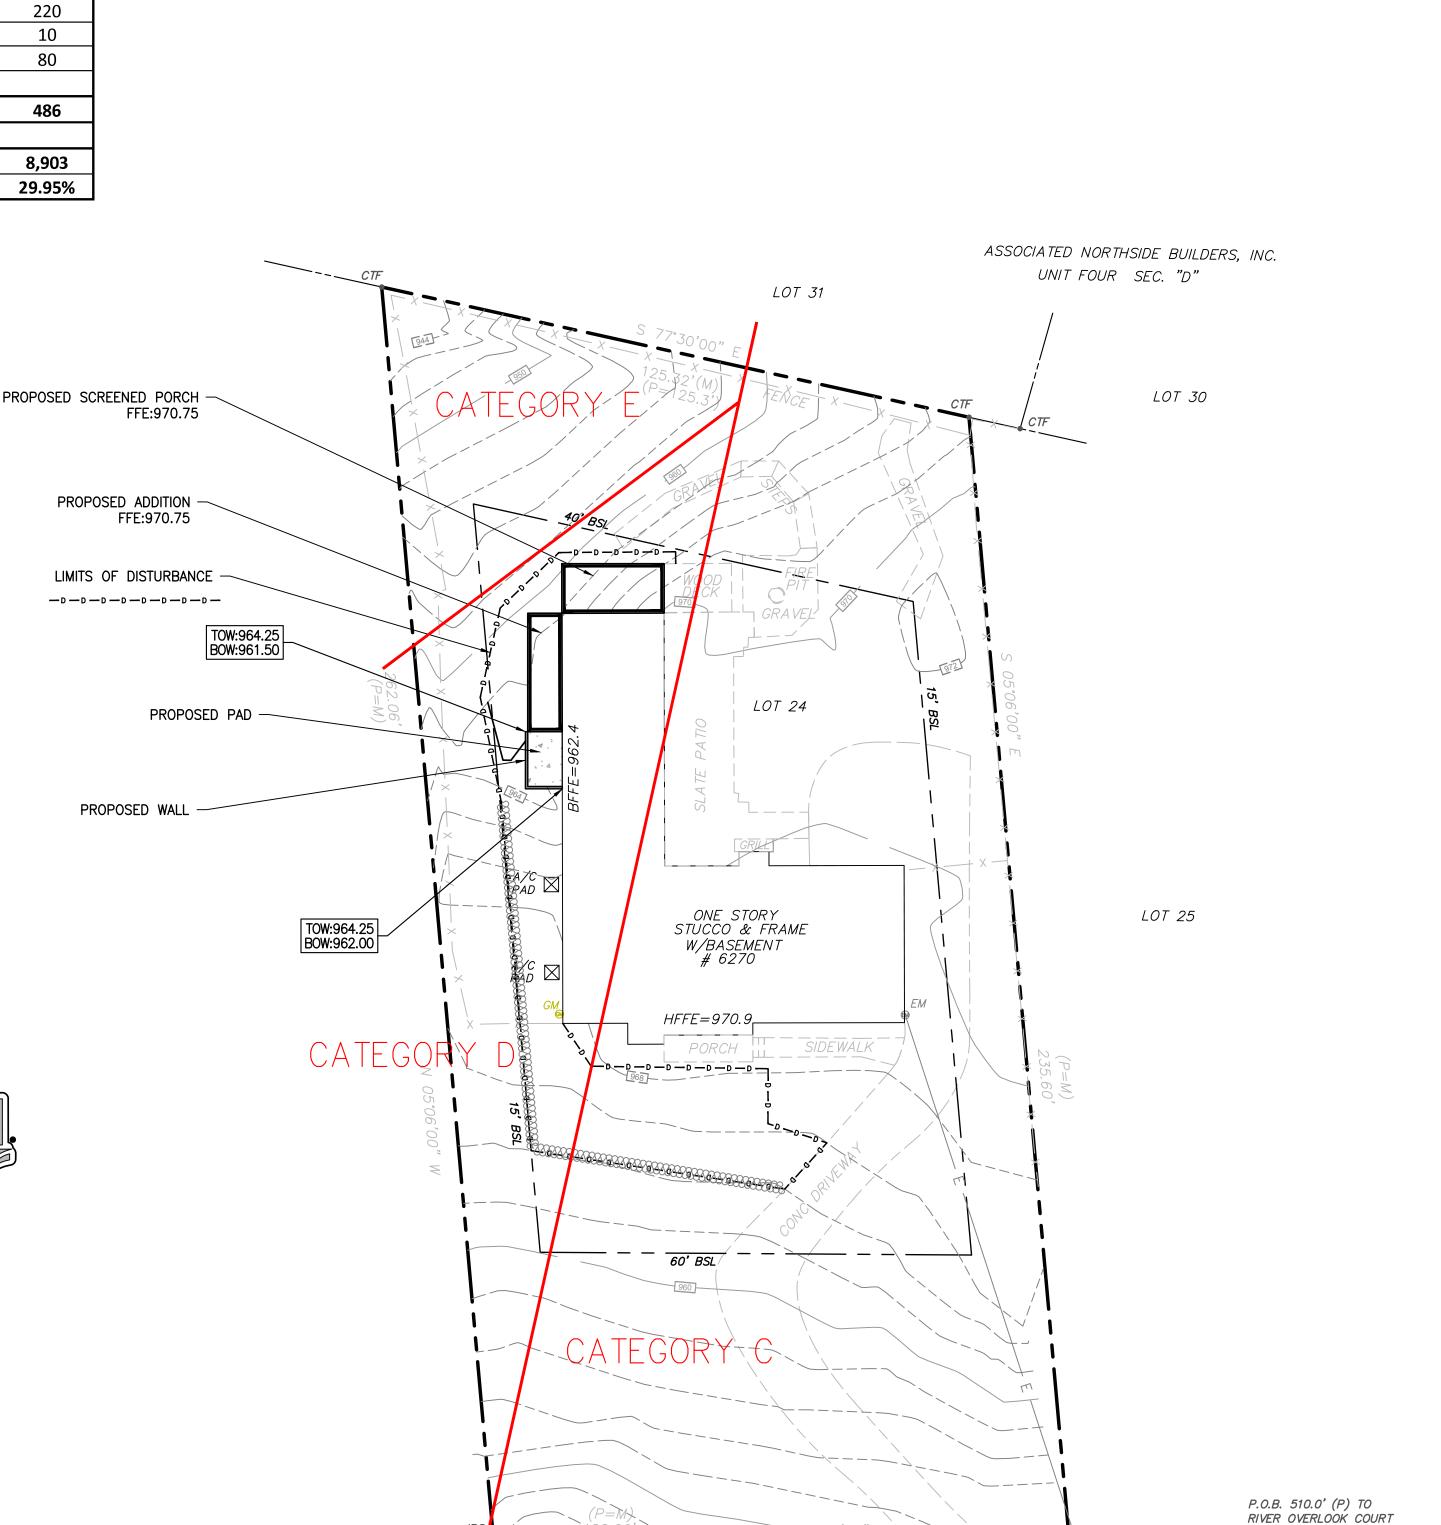

RIVER OVERLOOK DRIVE 50'R/W

SCALE: 1" = 20'

(NO MONUMENT FOUND)

Prepared For:
OMAN DES

DRIV **OK** Strict Site Plan For: **OVERL**ot 171, 17th I RIVEI Land f Sandy S 6270

CVE PI # 24-046 SHEET NO.

PROPOSED IMPERVIOUS = 486 SF LESS THAN 1000 SF. NO STORMWATER MANAGEMENT REQUIRED

ES&PC NOTES:

- 1. THE CONSTRUCTION PAD SHALL BE MAINTAINED IN A CONDITION WHICH WILL PREVENT TRACKING OR FLOW OF MUD ONTO PUBLIC STREETS.
- 2. SILT FENCES AND HAY BALE BARRIERS SHALL BE CLEANED OR REPLACED AND MAINTAINED IN FUNCTIONAL CONDITION UNTIL PERMANENT EROSION CONTROL MEASURES ARE ESTABLISHED.
- 3. ALL WORK SHALL BE PERFORMED IN ACCORDANCE WITH THE SPECIFICATION OF THE MANUAL FOR EROSION AND SEDIMENT CONTROL IN GEORGIA.
- 4. THE CONTRACTOR SHALL CLEAN OUT ALL ACCUMULATED SILT FROM THE SEDIMENT PONDS ONCE ALL DISTURBED AREAS ARE STABILIZED WITH PERMANENT VEGETATION.
- 5. EROSION CONTROL DEVICES WILL BE IN PLACE BEFORE SITE DISTURBANCE AND WILL BE PERIODICALLY INSPECTED AND REPAIRED OR RESTORED AS NEEDED TO FUNCTION PROPERLY UNTIL PERMANENT MEASURES ARE ESTABLISHED AND PROJECT IS COMPLETE, I.E.: CONSTRUCTION EXITS AND SILT FENCES SHALL BE RETOPPED OR CLEANED AS SILT REDUCES THEIR EFFECTIVENESS.
- 6. ANY ADDITIONAL CONSTRUCTION OTHER THAN SHOWN ON THIS PLAN WILL REQUIRE SEPARATE AND ADDITIONAL EROSION AND SEDIMENT CONTROL MEASURES AND APPROVAL.
- 7. TEMPORARY VEGETATION AND/OR HEAVY MULCH WILL BE USED TO STABILIZE AREAS. IN NO CASE SHALL A SITE BE LEFT BARE FOR MORE THAN 14 DAYS.
- 8. ALL DISTURBED AREAS WILL BE PERMANENTLY LANDSCAPED AND GRASSED AS SOON AS CONSTRUCTION PHASES PERMIT
- 9. ADDITIONAL MEASURES MAY BE REQUIRED TO CONTROL EROSION AS DETERMINED NECESSARY BY INSPECTORS
- 10. PERSON RESPONSIBLE FOR EROSION CONTROL MEASURES IS: 24 HOUR EMERGENCY CONTACT: BRANT GOODMAN 678-427-8466
- 11. CUT AND FILL SLOPES NOT TO EXCEED 2H: 1V.
- 12. SEDIMENTATION & EROSION CONTROL MEASURES TO BE INSPECTED DAILY.
- 13. EROSION CONTROL PRACTICES MUST COMPLY WITH THE MINIMUM BEST MANAGEMENT PRACTICES FOR EROSION CONTROL, AND SHALL COMPLY WITH THE STANDARDS/SPECIFICATIONS IN "THE MANUAL FOR EROSION AND SEDIMENT CONTROL IN GEORGIA"
- 14. SEDIMENT/EROSION CONTROL DEVICES MUST BE CHECKED AFTER EACH STORM EVENT. EACH DEVICE IS TO BE MAINTAINED OR REPLACED IF SEDIMENT ACCUMULATION HAS REACHED ONE THIRD THE CAPACITY OF THE DEVICE. ADDITIONAL DEVICES MUST BE INSTALLED IF NEW CHANNELS HAVE DEVELOPED.
- 15. BUILDER TO VERIFY ALL ELEVATIONS BEFORE ANY CONSTRUCTION.
- 16. THE CONSTRUCTION PAD SHALL BE MAINTAINED IN A CONDITION WHICH WILL PREVENT TRACKING OR FLOW OF MUD ONTO PUBLIC STREETS.
- 17. EROSION AND SEDIMENT CONTROL MEASURES SHALL BE MAINTAINED AT ALL TIMES. IF FULL IMPLEMENTATION OF THE APPROVED PLAN DOES NOT PROVIDE FOR EFFECTIVE EROSION CONTROL, ADDITIONAL EROSION AND SEDIMENT CONTROL MEASURES SHALL BE IMPLEMENTED TO CONTROL OR TREAT THE SEDIMENT SOURCE.
- 18. ADDITIONAL MEASURES MAY BE REQUIRED TO CONTROL EROSION AS DETERMINED NECESSARY BY INSPECTORS. THE EROSION CONTROL MEASURE CAN BE DESIGNED BY A LEVEL 1B (BLUE CARD) GASWCC CERTIFIED CONTRACTOR, UNLESS THE BMP HAS A HYDRAULIC COMPONENT. FOR ALL BMP DESIGN WITH A HYDRAULIC COMPONENT, THE BMP MUST BE DESIGNED BY A LEVEL 2 (GOLD CARD) GASWCC CERTIFIED DESIGNER.
- 19. WASTE MATERIALS SHALL NOT BE DISCHARGED TO WATERS OF THE STATE, EXCEPT AS AUTHORIZED BY A SECTION 404 PERMIT.


SEDIMENT STORAGE CALCULATIONS:


SILT FENCE PROVIDED = 95 LINEAR FEET OF SILT FENCE SEDIMENT STORAGE REQUIRED = 1.34 CU YD SEDIMENT STORAGE PROVIDED = 4.75 CU YD

CITY OF SANDY SPRINGS EROSION NOTES:

- 1. THE ESCAPE OF SEDIMENT FROM THE SITE SHALL BE PREVENTED BY THE INSTALLATION OF EROSION AND SEDIMENT CONTROL MEASURES AND PRACTICES PRIOR TO LAND DISTURBING ACTIVITIES.
- 2. EROSION CONTROL MEASURES WILL BE MAINTAINED AT ALL TIMES. IF FULL IMPLEMENTATION OF THE APPROVED PLAN DOES NOT PROVIDE FOR EFFECTIVE EROSION CONTROL, ADDITIONAL EROSION AND SEDIMENT CONTROL MEASURES SHALL BE IMPLEMENTED TO CONTROL OR TREAT THE SEDIMENT SOURCE.
- 3. ANY DISTURBED AREA LEFT EXPOSED FOR A LONGER PERIOD GREATER THAN 14 DAYS SHALL BE STABILIZED WITH MULCH OR TEMPORARY SEEDING.

24 HOUR EMERGENCY CONTACT: BRANT GOODMAN 678-427-8466

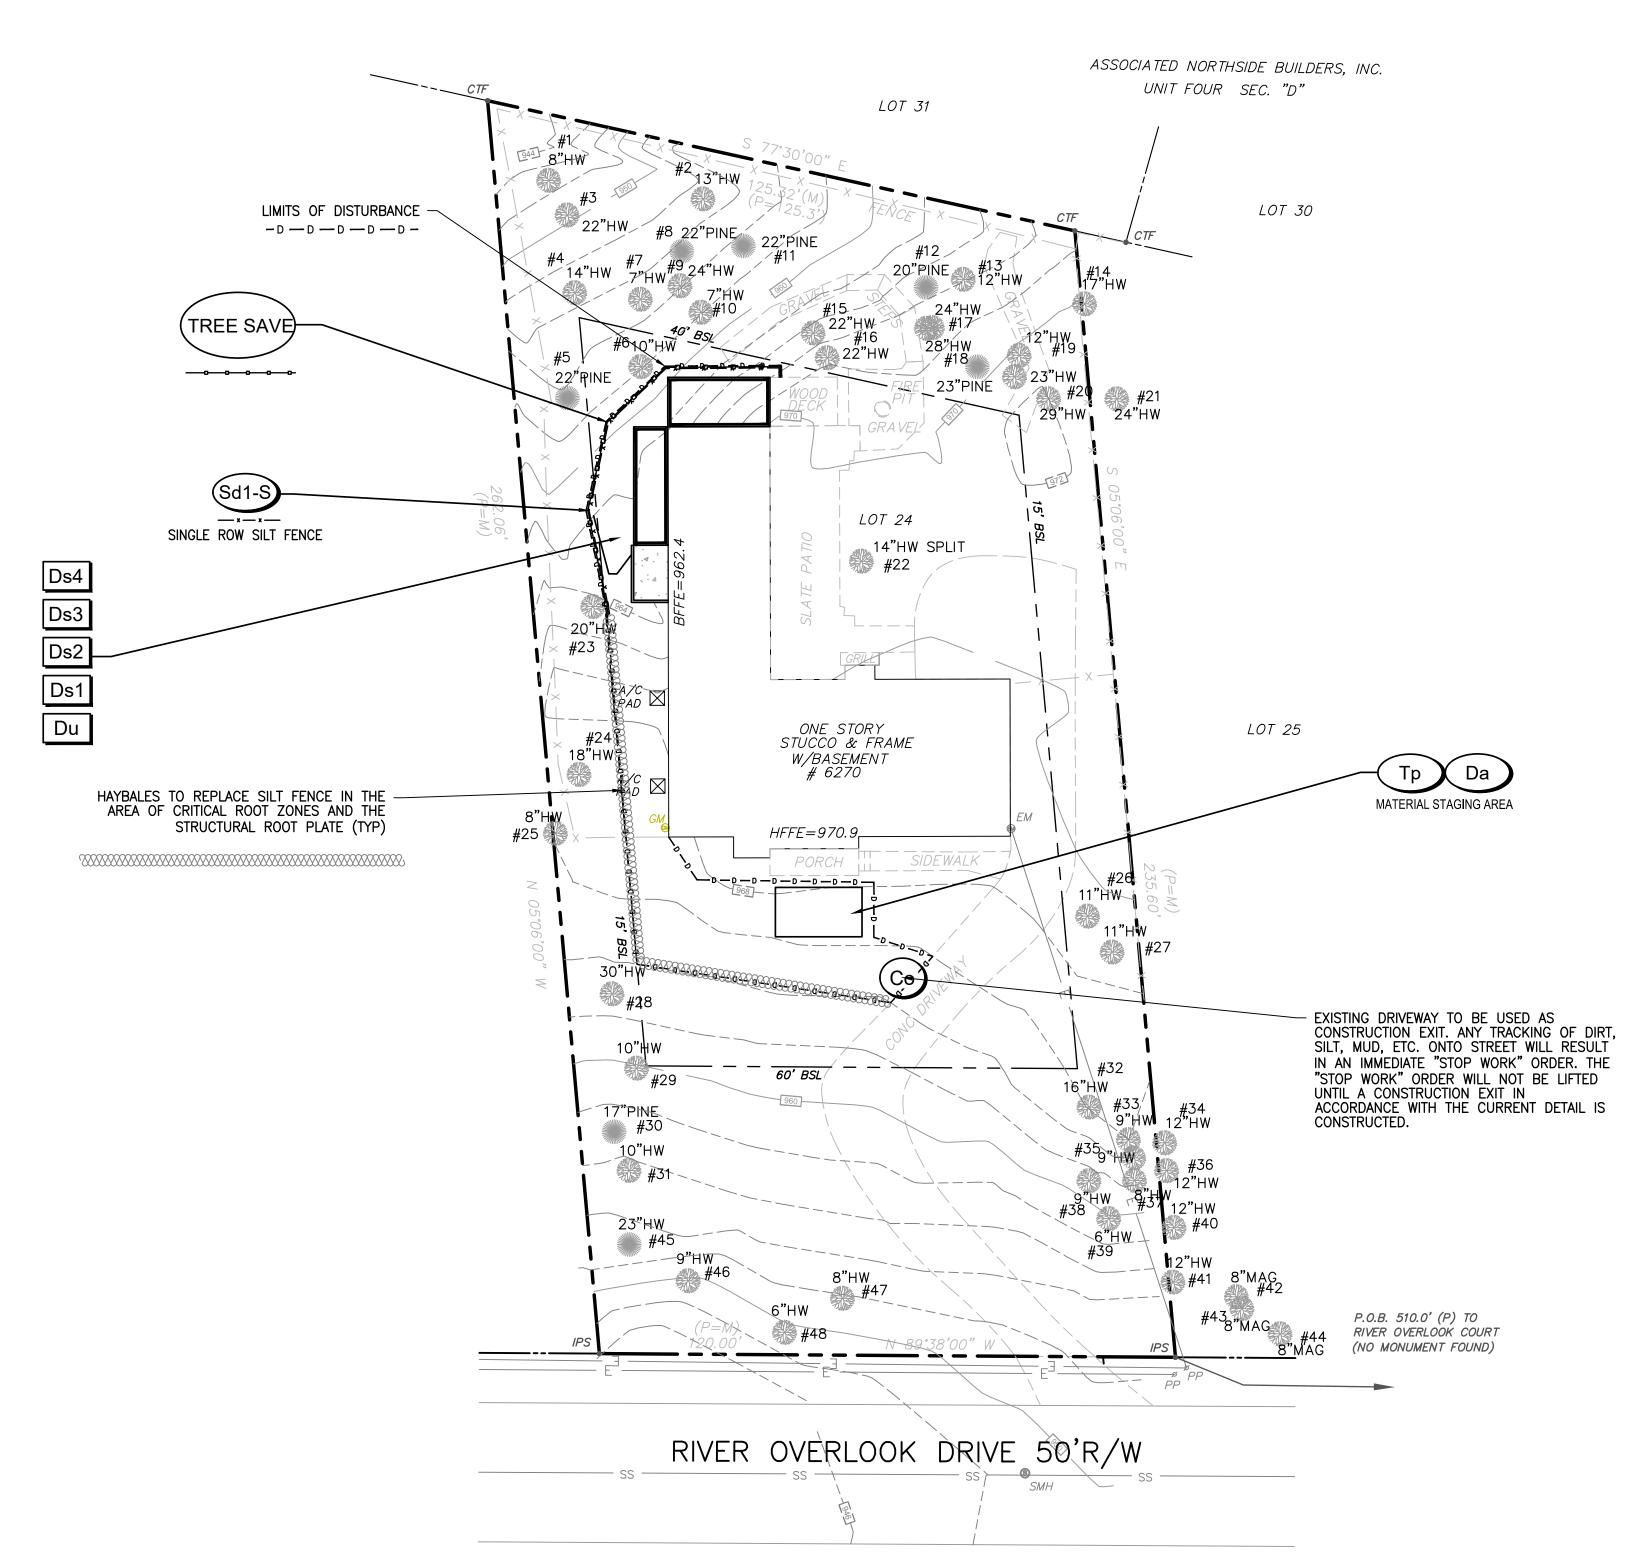

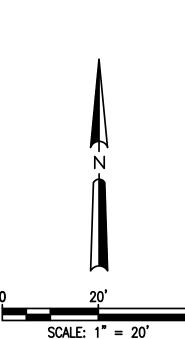

CRESCENT VIEW
INGINEERING, LLC:
211 Frasier Street
Marietta, GA 30060
678-324-8410
www.crescentvieweng.com

Prepared For:
ODMAN DESIGNS
1877 ARDMORE RD NW
Atlanta, GA 30309
678-427-8466

C PLAN
REVISIONS

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ES&

Site Plan For:

6270 RIVER OVERLOOK DRIVE

Land Lot 171, 17th District
City of Sandy Springs, Fulton County, Georgia

CVE PI # 24-046

SHEET NO.

C-2

TREE LIST:

TREE #	DBH	TYPE	REMOVE	ONSITE	SETBACK	BOUNDARY TREE (>/=10")	PROTECTED TREE	LANDMARK TREE	SETBACK MITIGATIO N (>/=10")	TREE CRZ	% IMPACT
1	8	HARDWOOD		Х						314	0.00%
2	13	HARDWOOD		Х						830	0.00%
3	22	HARDWOOD		Х			Х			2376	0.00%
4	14	HARDWOOD		Х						962	0.00%
5	22	PINE		Х	Х		Х			2376	18.94%
6	10	HARDWOOD	Х	Х						491	28.52%
7	7	HARDWOOD		Х						241	0.00%
8	22	PINE		Х			Х			2376	2.15%
9	24	HARDWOOD		Х			Х			2827	0.00%
10	7	HARDWOOD		Х						241	4.57%
11	22	PINE		Х			Х			2376	1.56%
12	20	PINE		Х			Х			1963	0.00%
13	12	HARDWOOD		Х						707	0.00%
14	 17	HARDWOOD				Х				1419	0.00%
15	22	HARDWOOD		Х			Х			2376	8.08%
16	22	HARDWOOD		X			X			2376	7.74%
17	24	HARDWOOD		X			X			2827	0.00%
18	28	HARDWOOD		X			<u> </u>	Х		3848	0.00%
19	12	HARDWOOD		X						707	0.00%
20	29	HARDWOOD		X				Х		4128	0.00%
21	24	HARDWOOD				Х	Х	^		2827	0.00%
22	14	HARDWOOD		Х		^	^			962	0.00%
23	20	HARDWOOD	X	X	Х		X			1963	24.45%
23	18	HARDWOOD		X	X		X			1590	0.00%
25	8	HARDWOOD								314	0.00%
		HARDWOOD		X	X					594	
26	11				X						0.00%
27	11	HARDWOOD		X	X			V		594	0.00%
28	30	HARDWOOD		X	X			X		4418	0.00%
29	10	HARDWOOD		X	Х					491	0.00%
30	17	PINE		X						1419	0.00%
31	10	HARDWOOD		X						491	0.00%
32	16	HARDWOOD		X						1257	0.00%
33	9	HARDWOOD		Х		.,,				398	0.00%
34	12	HARDWOOD		.,,		Х				707	0.00%
35	9	HARDWOOD		Х						398	0.00%
36	12	HARDWOOD	-			Х				707	0.00%
37	8	HARDWOOD		X						314	0.00%
38	9	HARDWOOD		X						398	0.00%
39	6	HARDWOOD		Х						177	0.00%
40	12	HARDWOOD				X				707	0.00%
41	12	HARDWOOD				X				707	0.00%
42	8	MAGNOLIA								314	0.00%
43	8	MAGNOLIA								314	0.00%
44	8	MAGNOLIA								314	0.00%
45	23	HARDWOOD		Х			Х			2597	0.00%
46	9	HARDWOOD		Х						398	0.00%
47	8	HARDWOOD		Х						314	0.00%
48	6	HARDWOOD		X			1			177	0.00%

TREE CALCULATIONS:

CONTACT THE DEPARTMENT OF COMMUNITY DEVELOPMENT AT (770)730-5660 TO ARRANGE A PRE-CONSTRUCTION MEETING WITH THE SITE INSPECTOR PRIOR TO ANY LAND DISTURBANCE, BUILDING CONSTRUCTION, OR DEMOLITION.

1. <u>CANOPY COVERAGE - EXISTING TO REMAIN</u>
NOTE - IF SPECIFIC SPECIES WERE NOT PROVIDED BY SURVEY, THEREFORE THE SMALLER CANOPY COVERAGE FOR TREE TYPE HARDWOOD WAS SELECTED TO PROVIDE A CONSERVATIVE ESTIMATION, WITH EXCEPTION OF LANDMARK TREES, WHICH WERE GIVEN THE 1000 SF CANOPY COVERAGE ESTIMATION. (4) PINE TREE AT 1,000 SF = 4,000 SF

(7) HARDWOOD TREE AT 1,000 SF = 7,000 SF

(3) LANDMARK HARDWOOD TREE AT 1,250 SF = 3,750 SF

= 14,750 SF (TOTAL CANOPY REMAINING) $= 35\% \times LOT AREA = 29,724 \times 0.35 = 10,403.4 SF$ REQUIRED CANOPY

REQUIREMENT MET THROUGH EXISTING TREES

2. REPLACEMENT/RECOMPENSE — LANDMARK TREES REQUIRED RECOMPENSE/REPLACEMENT = PER CITY OF SANDY SPRINGS, REQUIRED REPLACEMENT IS 150% CANOPY PER EACH LANDMARK TREE REMOVED O LANDMARK TREES TO BE REMOVED

3. RESIDENTIAL FRONT YARD TREES PER SEC. 8.2.3.
PER SECTION 8.2.3, THERE IS TO BE ONE SHADE TREE PLANTED IN THE FRONT YARD PER EVERY 40 FT OF FRONTAGE: TOTAL FRONTAGE = 120 FT = 3 REQUIRED FRONT YARD TREES

EXISTING FRONT YARD TREES = 14 TREE

REQUIREMENT MET THROUGH EXISTING TREES

4. YARD DISTURBANCE MITIGATION CALCULATION
PER CODE SECTION 9.4.2.G: FOR EACH TREE OF 10 INCHES DBH OR GREATER REMOVED OR DAMAGED BY GRADING IN THE SIDE SETBACK, ONE TREE MUST BE PLANTED.

TOTAL TREES LOST IN SIDE YARD = 1 REMOVED 20 INCHES REPLACEMENT TREES = 2 QTY

5. TOTAL PROPOSED REPLACEMENT CANOPY (CODE SEC. 9.3.8.D.2)
PROPOSED EXISTING CANOPY TO REMAIN = 14,750 SF REQUIRED CANOPY = 35% X 29,724 SF = 10,403.4 SF

= 15,750 SF TOTAL PRE-CONSTRUCTION CANOPY TOTAL POST CONSTRUCTION CANOPY (BEFORE PLANTING) = 14,750 SF

CANOPY REQUIREMENT ASSESSED VALUE OF \$1,200 / 1,000 SF OF CANOPY PER DEFICIENT - CONSTRUCTION DOES NOT CAUSE CANOPY TO DROP BELOW MINIMUM REQUIRED CANOPY.

CITY OF SANDY SPRINGS LANDSCAPE NOTES:

CONTACT THE DEPARTMENT OF COMMUNITY DEVELOPMENT AT (770)730-5660 OR THROUGH PORTAL TO ARRANGE A PRE-CONSTRUCTION MEETING WITH THE SITE INSPECTOR PRIOR TO ANY LAND DISTURBANCE, BUILDING CONSTRUCTION, OR DEMOLITION.

SIDE SETBACK MITIGATION TREE LEGEND:

Figure 5 - Tree Planting Standard Detail (not to scale)

Provide 2-4" approved mulch throughout plant beds, do not place against trunk as shown-

TREE PLANTING DETAIL

NOT TO SCALE

SOUTHERN MAGNOLIA - 2 QTY - 3" CALIPER

Where tree protection is adjacent to erosion control fencing, tree fence must be visible and at full 4' height min. on the inside of tree save area.

Locate fencing at edge of CRZ, or against pavement edges, as per approved site plans.

. Fencing must remain through the duration of all construction activities. Removal or relocation of fencing for temporary access must be replaced daily and immediately upon completion of work requiring access. Temporary access must be approved in advance by the COSS Arborist.


FENCE LOCATION

at edges of Critical Root Zone: CRZ ——
diameter = 15 x DBH

TREE SAVE FENCE DETAIL

Use as many stakes as required to extend fencing to furthest limits of CRZ or as shown on plans

NOT TO SCALE

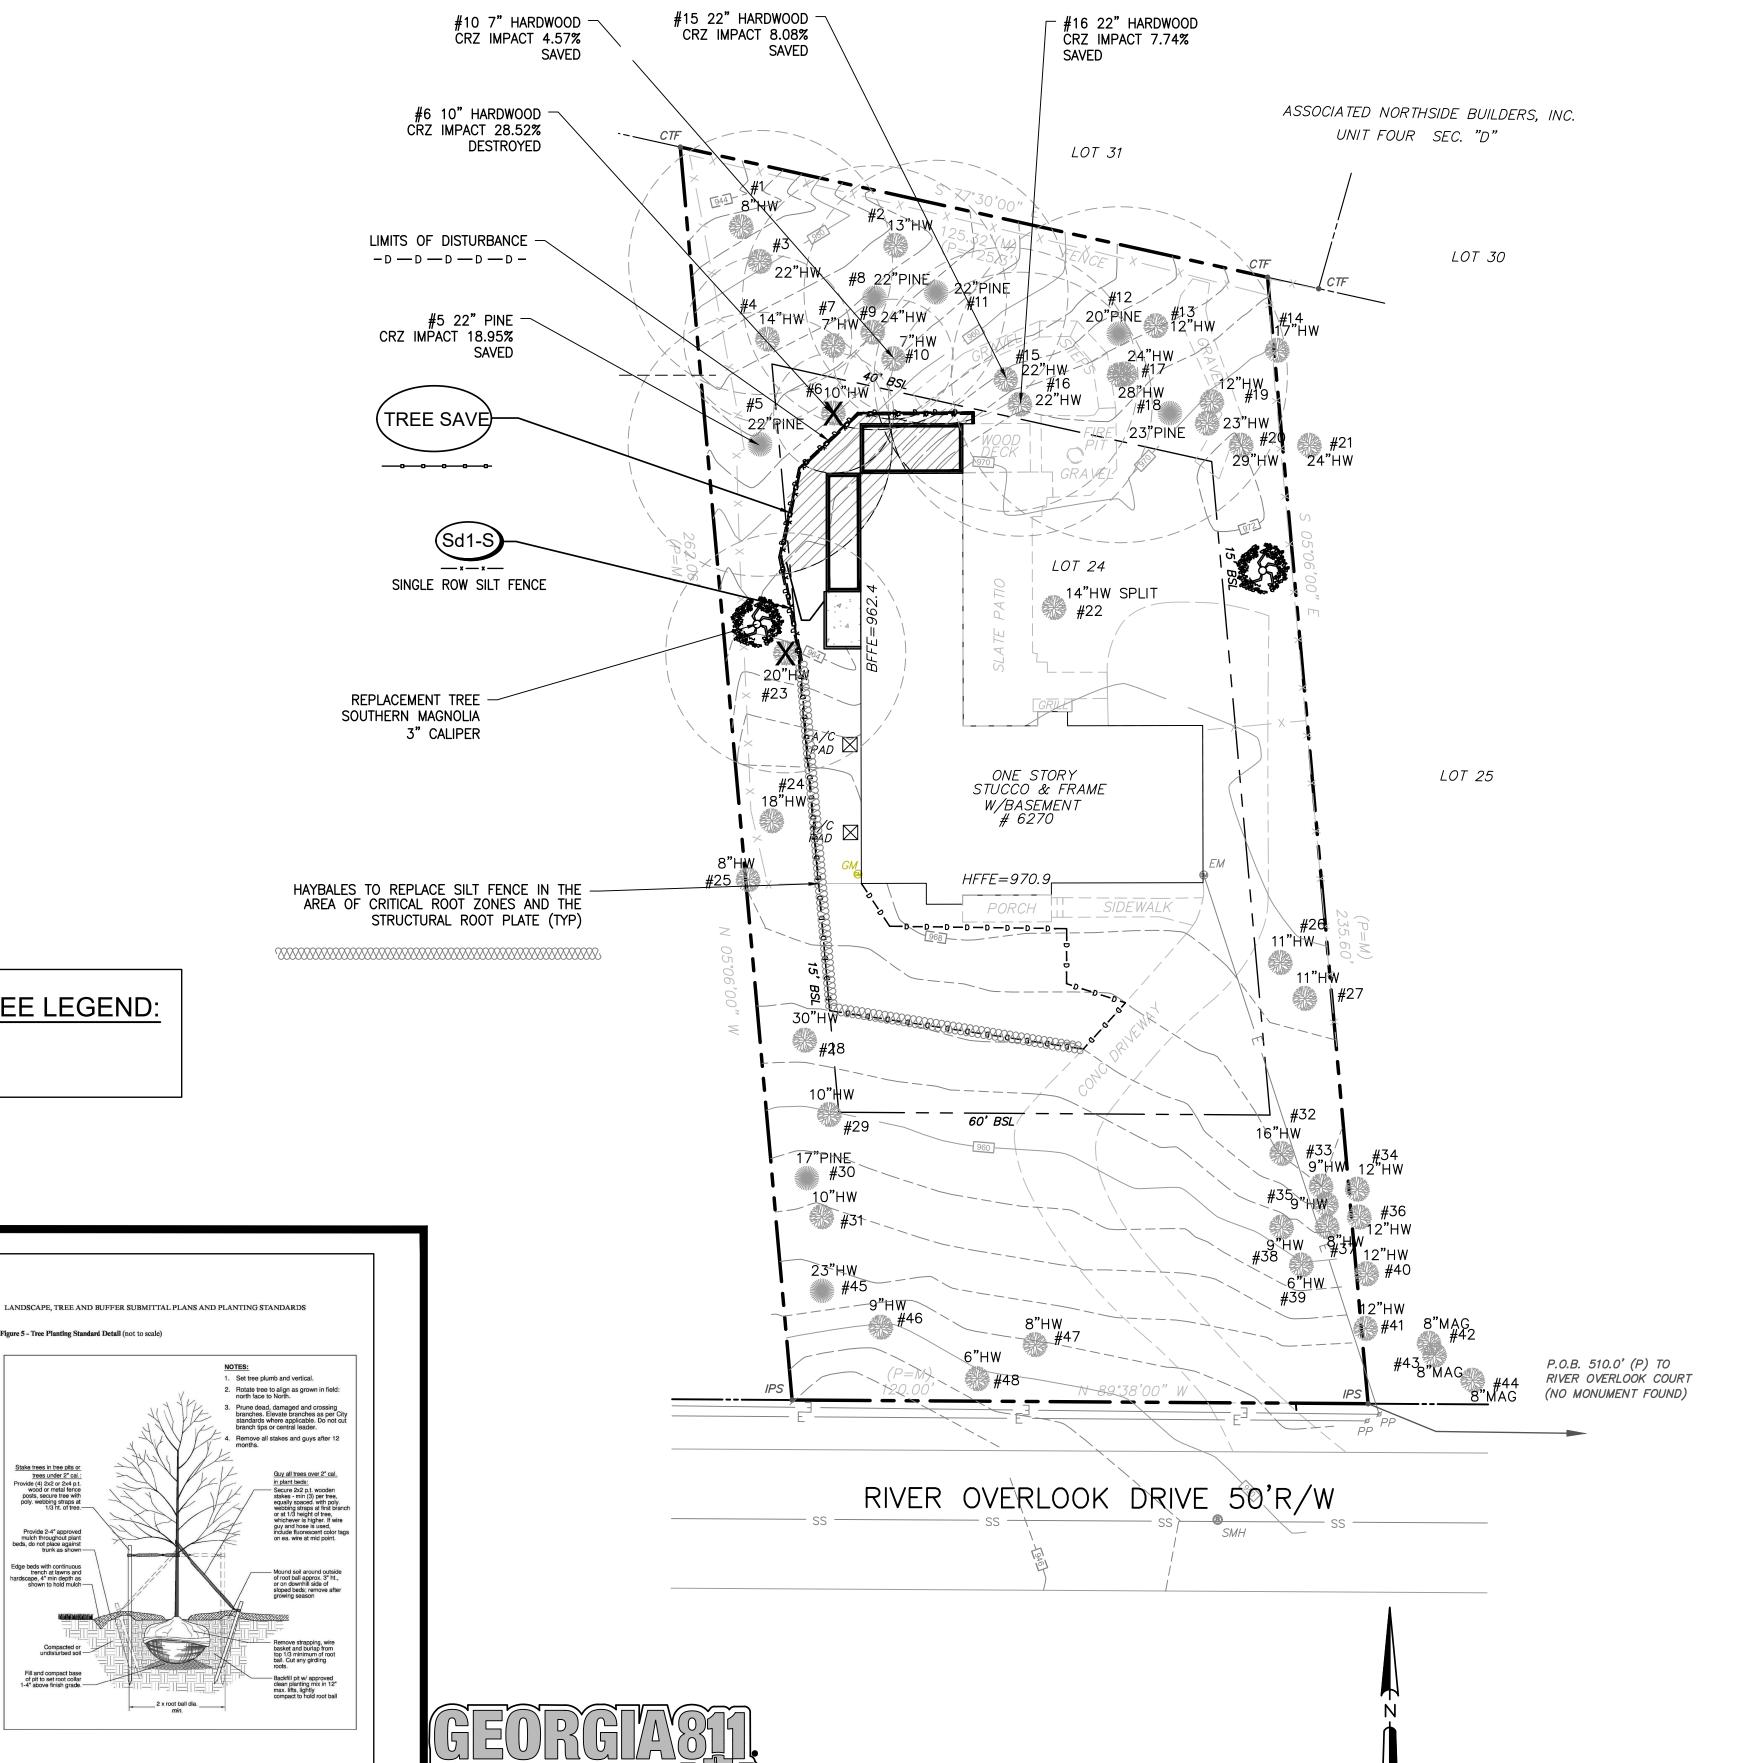

24 HOUR EMERGENCY CONTACT: BRANT GOODMAN 678-427-8466

Prepared For: GOODMAN DE


PLAN TRE

DRIVE OOK District County, Site Plan For:
OVERL
ot 171, 17th Edings, Fulton RIVER
Land Lo 6270

CVE PI# 24-046

SHEET NO.

SCALE: 1" = 20'

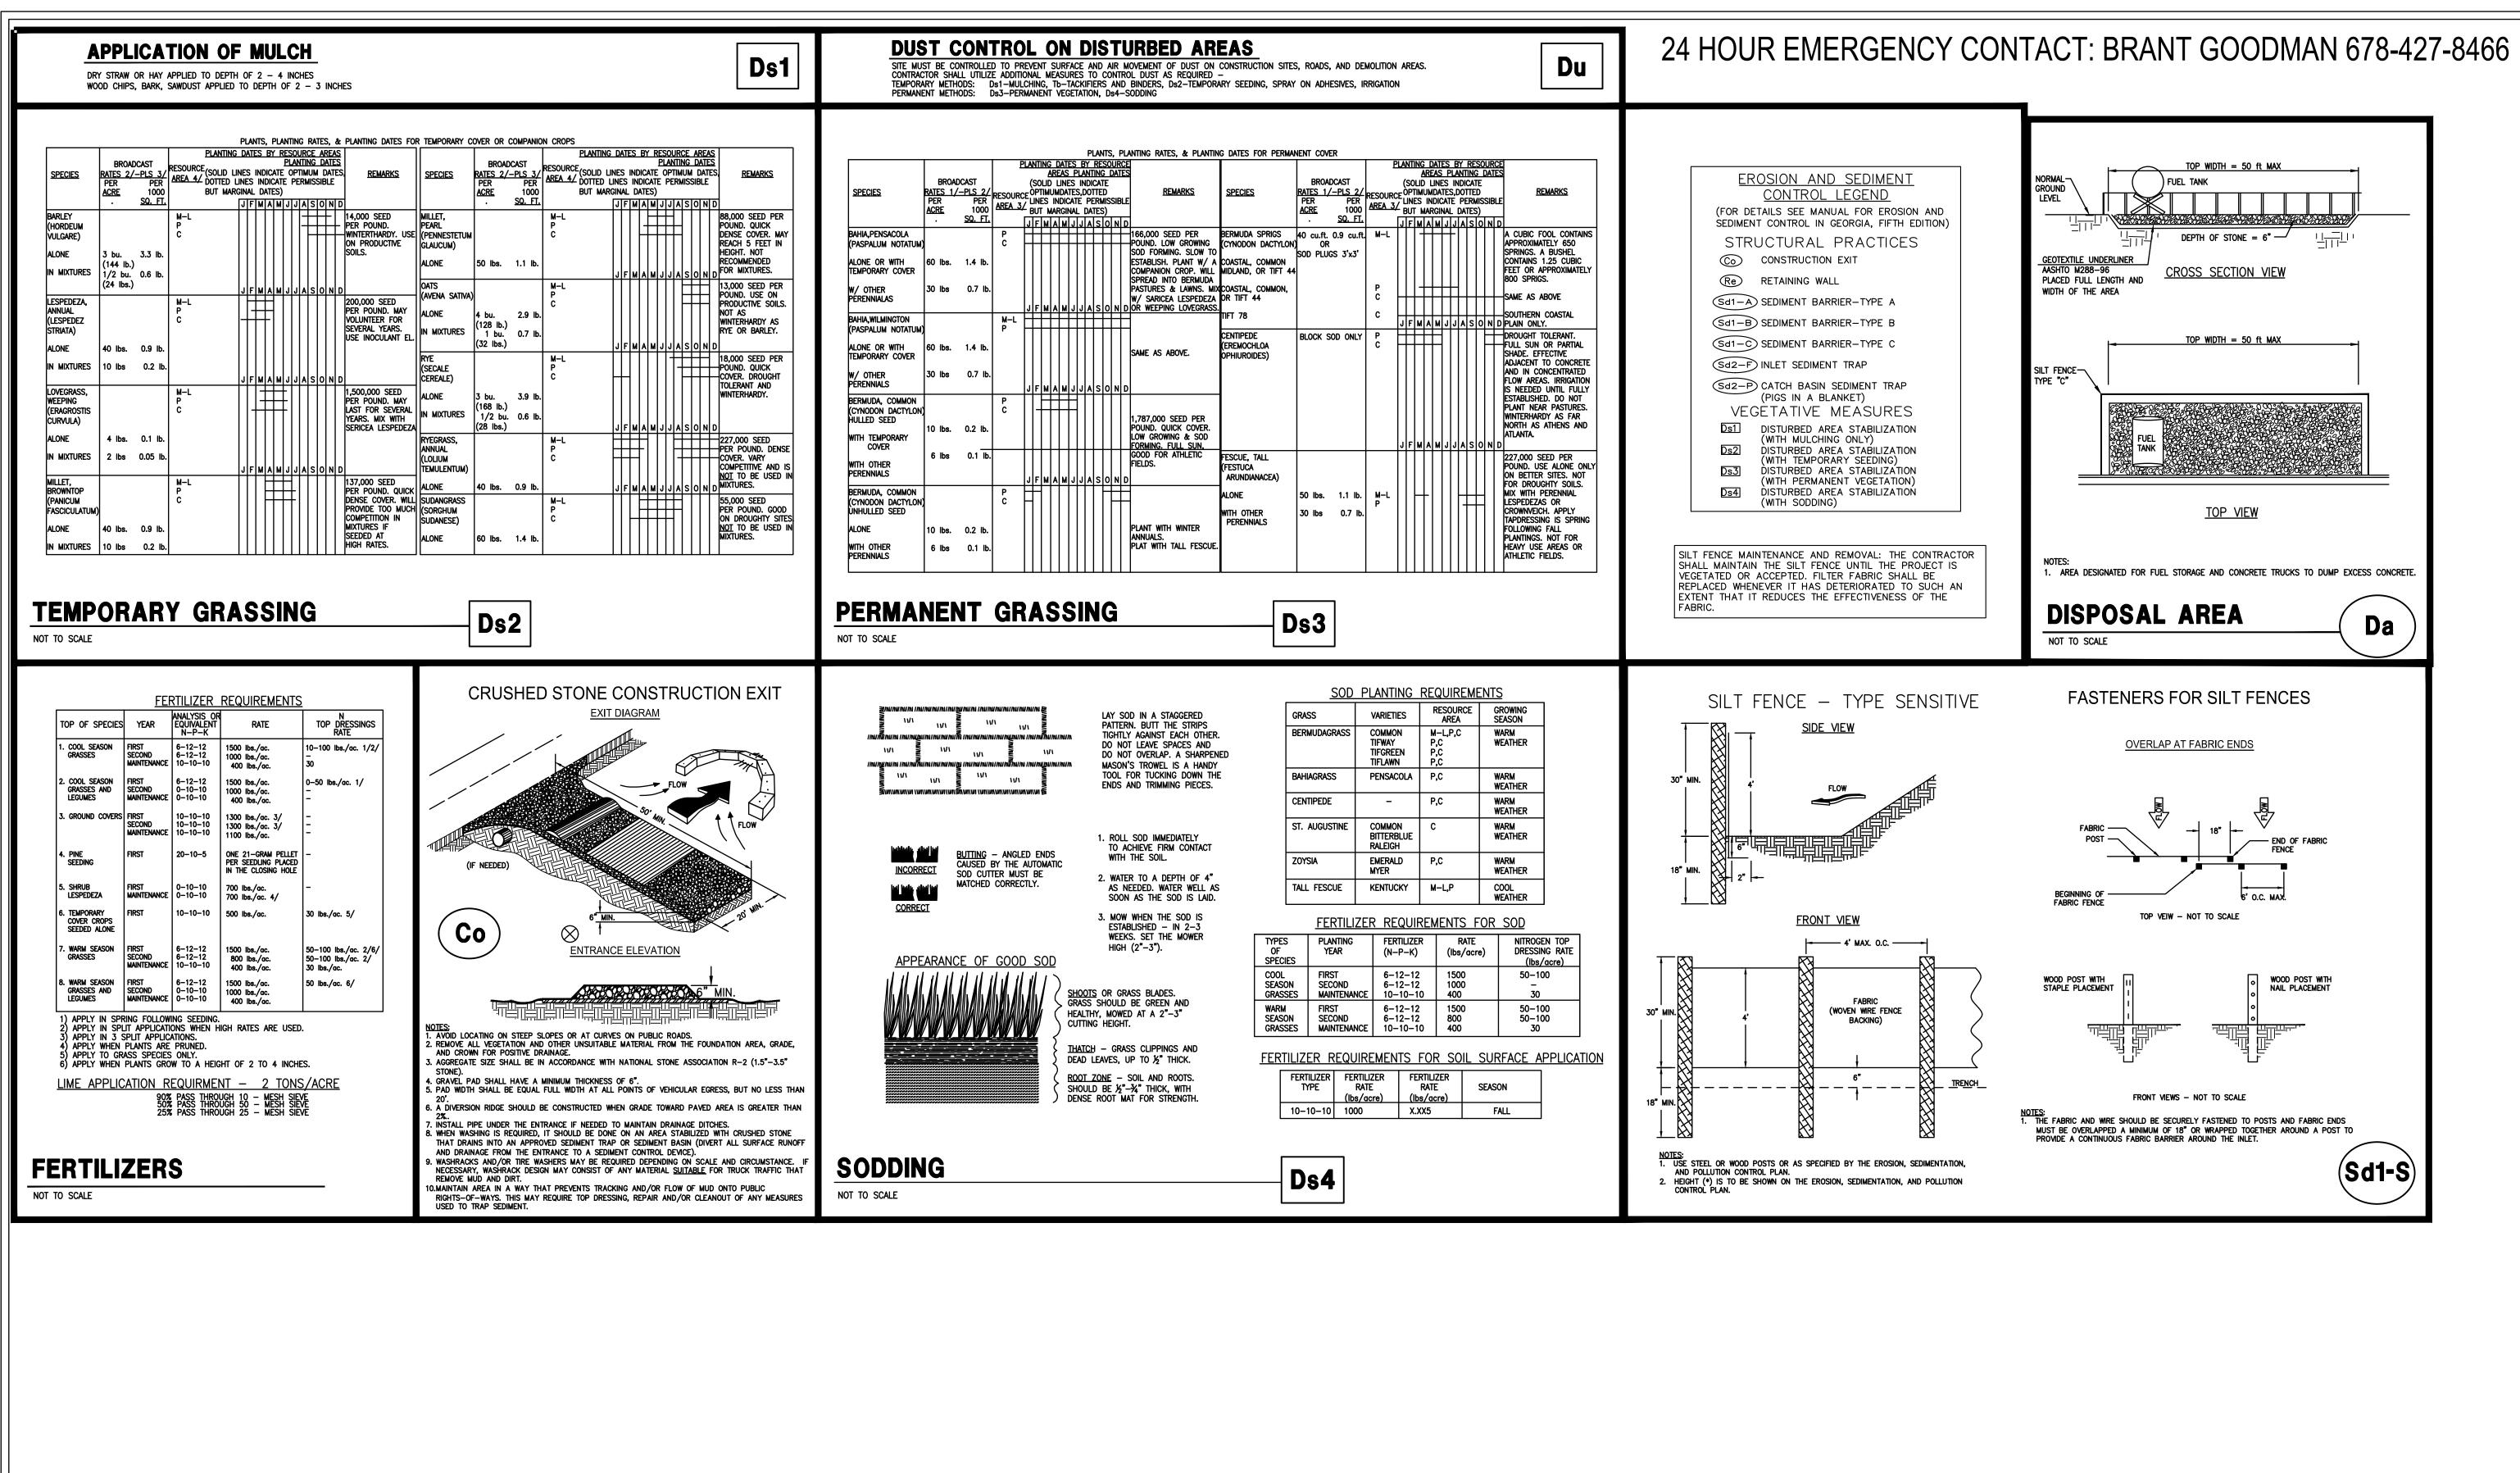

CONSTRU C. K. C. N.C. INEER AS SHOWN AHG

Prepared By: CRESCENT VIEW ENGINEERING, LLC:

DE POL

DMAN [

GO

Site Plan For:

6270 RIVER OVERLOOK DRIVE

Land Lot 171, 17th District
City of Sandy Springs, Fulton County, Georgia

SHEET NO.

C-4