

REGIONAL REVIEW FINDING

Atlanta Regional Commission • 229 Peachtree Street NE | Suite 100 | Atlanta. Georgia 30303 • ph: 404.463.3100 fax: 404.463.3205 • atlantaregional.org

DATE: OCTOBER 2, 2023

TO:

MAYOR ANDRE DICKENS, City of Atlanta

ATTN TO:

KEYETTA HOLMES, ZONING AND DEVELOPMENT DIRECTOR, City of Atlanta

FROM:

Anna Roach, Executive Director, Atlanta Regional Commission

ARC has completed a regional review of the following proposal and made the below finding. ARC reviewed the proposed project's relationship to regional plans, goals, and policies and impacts it might have on the activities, plans, goals, and policies of other local jurisdictions and state, federal, and other agencies.

Name of Proposal: RC-23-09A 2167 Main Street NW

Submitting Local Government: City of Atlanta

Date Opened: September 13, 2023

Date Closed: October 2, 2023

<u>FINDING</u>: ARC staff have completed a review of an application for a MRPA Certificate for this proposed project in the Chattahoochee River Corridor. ARC's finding is that the project is consistent with the Chattahoochee River Corridor Plan.

Additional Comments: No comments were received.

THE FOLLOWING LOCAL GOVERNMENTS AND AGENCIES RECEIVED NOTICE OF THIS REVIEW:

ATLANTA REGIONAL COMMISSION

GEORGIA DEPARTMENT OF NATURAL RESOURCE

CHATTAHOOCHEE RIVERKEEPER

NATIONAL PARK SERVICE

GEORGIA CONSERVANCY

CITY OF SMYRNA

HISTORIC RIVERLINE COBB COUNT

For questions, please contact Donald Shockey at (470) 378-1531 or dshockey@atlantaregional.org. This finding will be published to the ARC website at https://atlantaregional.org/plan-reviews.



APPLICATION FOR ETROPOLITAN RIVER PROTECTION ACT CERTIFICATE

City of Atlanta (Fulton county)

1.	Name of Local G	Sovernment:				
2.	Owner(s) of Rec	ord of Property to be Review	ed:			
	Name(s).	0.0.4.1				
	Mailing Add	dress: 1396 Everhart st SW	/			
	City: Atla	dress: 1396 Everhart st SW nta	State:	GA	Zip:	30310
		one Numbers (w/Area Code):				
		Phone: 5042347292		Fax:		
		umbers:				
3.	Applicant(s) or A	Applicant's Agent(s):				
		Ahjai Fortune				
		dress: 1396 Everhart st SW	/			
		nta		GA	Zip:	30310
	Contact Pho	one Numbers (w/Area Code):				
		Phone: 5042347292		Fax:		
		umbers: 4043261768				
5.		otion (Attach Legal Descripti , District, Section, County:				lton
		il district: 9		<u> </u>	<u> </u>	
		, Lot, Block, Street and Addr	ess. Dist	ance to Neare	st Intersection:	
	Subdivision		,		_	
	Size of Deve	elopment (Use as Applicable):				
	Acres:					
		Outside Corridor: 1,2	27 sqft			
		Outside Corridor: 1,2 Total: 0.1361 8,4				
	Lots:	Inside Corridor:				
		Outside Corridor:				
	Units:	Inside Corridor:				
		Outside Corridor:				
		Total: 1				
	Other Size I	Descriptor (i.e., Length and W	Vidth of	Easement):		
		Inside Corridor:				
		Outside Corridor:				
		Total:				



A. 1	is not part of this app	pment include addir plication? No	nt: tional land in the Chat d any development pla		
B. 1	Has any part of the p bordering this land, Corridor review app If "yes", please ident	property in this appl previously received roval? No ify the use(s), the re	ication, or any right-of a certificate or any oth	f-way or easen ner Chattahood mber(s), and th	nent chee
A. S B. 1	local government h Public sewer system_	s with septic tanks, ealth department a Public sewer	the application must in	d site.	ropriate
Vulnerab Categor	•	ge) (or Sq. Footag Land Disturba	9		
A				(90)	_(75)
B C	6,307 sqft	4,268 sqft	2,373 sqft	(80) (70) ^{67.7}	_(45)37_
D	964 sqft	0 sqft	0 sqft	(50) 0	(30) 0
E				(30)	_(15)
F				(10)	(2)
Total:	7,271 sqft	4,268 sqft	2,373 sqft	N/A	N/A



9.	Is any of this Land within the 100-Year Floodplain of the Chattahoochee River? No	DATE:06
•	If "yes", indicate the 100-year floodplain elevation:	
	NOTE: For this review, river floodplain is determined from the U.S. Army Corps of	
	Engineers' "Floodplain Information - Chattahoochee River, Buford Dam to	
	Whitesburg, Georgia", November, 1973 and its Supplement of March, 1982.	
	NOTE: All river 100-year floodplain is assigned to the "E" Category; its allowable	
	allocations can be combined with those of other "E" land in the review. Also	100_
	year floodplain cannot be reanalyzed and cannot accept transfers.	, 100-
	year modupiam cannot be reanaryzed and cannot accept transfers.	
10.	Is any of this land within the 500-year floodplain of the Chattahoochee River? No	
10.	If "yes", indicate the 500-year flood plain elevation:	-
	NOTE: Plan Standards include a 35-foot height limit above the pre-construction	
	grade within the 500-year floodplain (includes the 100-year floodplain).	
	Adherence to this standard must be noted on the submitted plans (see Part	
	2.B.(4) of the <u>Chattahoochee Corridor Plan</u>).	
11.	The following is a checklist of information required to be attached as part of the	
	application. Individual items may be combined.	
FO	RALL APPLICATIONS:	
_	Description of land in the application and any additional land in the project (attach legal	
	description or surveyed boundaries).	
	Alama addition and about any low (a) of any or (a) of any and of the land in the any limited	
	Name, address, and phone number(s) of owner(s) of record of the land in the application.	
	(Space provided on this form)	
	Written consent of all owners to this application. (Space provided on this form)	
	_ written consent of an owners to this application. (Space provided on this form)	
	Name, address, and phone number(s) of applicant or applicant's agent. (Space provided	
	on this form)	
	Description of proposed use(s). (Space provided on this form)	
_	Existing vegetation plan.	
	Proposed grading plan.	
	Certified as-builts of all existing land disturbance and impervious surfaces.	
	ecitifica as-builts of all existing faild disturbance and impervious surfaces.	
	Approved erosion control plan.	
_	- FF	
	Detailed table of land-disturbing activities. (Both on this form and on the plans)	
	_ ` ` ` ` ` ` ` '	

	Plat-level plan showing (as applicable): lot boundaries; any ot and rights-of -way; 100- and 500-year river floodplains; vulne	· ·	ements
	boundaries; topography; any other information that will clari		MRPA-23-008
<u> </u>	Documentation on adjustments, if any.		OFFICE OF ZONING & DEVELOPMENT
	Cashier's check or money order (for application fee).		DATE: 06/16/2023
	SINGLE-STEP APPLICATIONS (NON-SUBDIVISION): Site plan.		
	Land-disturbance plan.		
FOR	TWO-STEP SINGLE-FAMILY SUBDIVISION APPLICATI Concept plan.	ONS ONLY:	
	Lot-by-lot and non-lot allocation tables.		
12.	I (we), the undersigned, authorize and request review of this a under the provisions of the Metropolitan River Protection Act necessary)	* *	
		6/1/2023	
	Signature(s) of Owner(s) of Record	Date	
13.	I (we), the undersigned, authorize and request review of this a under the provisions of the Metropolitan River Protection Act	• •	ficate
	Signature(s) of Applicant(s) or Agent(s)	Date	
14. requ	The governing authority ofCity of Atlantaestriew by the Atlanta Regional Commission of the above-desc Provisions of the Metropolitan River Protection Act.	ribed use under the	
	Keyetta M. Holmes	9/07/2023	
	Keyetta M. Holmes Signature of Chief Elected Official or Official's Designee	Date	

SITE ADDRESS: 2167 MAIN STREET NW, ATLANTA GA 30318

SURVEY INFORMATION IS TAKEN FROM SURVEY PERFORMED BY C&A INVESTORS, DATED 9-28-20

TOPOGRAPHY INFORMATION TAKEN FROM FULTON COUNTY GIS

THIS PROPERTY IS NOT LOCATED INSIDE DESIGNATED F.I.A SPECIAL FLOOD HAZARD AREA AS PER THE FLOOD INSURANCE RATE MAP #13121C0228F, DATED SEPTEMBER 18, 2013

THERE ARE NO KNOWN WETLANDS ON THE PROJECT SITE.

THERE ARE NO KNOWN STREAMS, ALL ASSOCIATED STREAM BUFFERS AREAS ASSOCIATED WITH THE PROPERTY ARE SHOWN ONSITE.

TO THE BEST OF OUR KNOWLEDGE, THERE ARE NO CEMETERIES, ARCHITECTURAL, OR ARCHEOLOGICAL LANDMARKS THAT EXIST ON SITE. IN THE EVENT THAT THESE LANDMARKS ARE DISCOVERED DURING CONSTRUCTION, THE ENGINEER MUST BE CONTACTED IMMEDIATELY FOR REVIEW AND AMENDING THE CONSTRUCTION PLANS.

THE EXISTING UTILITIES SHOWN ON THE PLANS ARE SHOWN FOR THE CONTRACTOR'S CONVENIENCE. THE ENGINEER ASSUMES NO RESPONSIBILITY FOR THE LOCATIONS, SIZES, MATERIALS, OR DEPTH FOR THE UTILITIES SHOWN OR THE UTILITIES WHICH MAY EXIST ON THE SITE BUT ARE NOT SHOWN. THE CONTRACTOR SHALL HAVE THE RESPONSIBILITY TO VERIFY THE LOCATION OF ALL UTILITIES SHOWN ON THE PLANS AND REPORT ANY DISCREPANCIES TO THE ENGINEER OF RECORD. THE CONTRACTOR SHALL ALSO HAVE THE RESPONSIBILITY BEFORE STARTING ANY WORK TO MAKE SUCH EXPLORATIONS AND PROBES NECESSARY TO ASCERTAIN ANY SEWER LINES, WATER SUPPLY LINES, GAS LINES, ELECTRICAL LINES, CABLE LINES, TELEPHONE LINES, OR OTHER UTILITY LINE.

CONTRACTOR SHALL CONTACT THE UTILITY LOCATOR AS REQUIRED BY GEORGIA LAW AND HAVE ALL UTILITIES MARKED PRIOR TO ANY CONSTRUCTION ACTIVITY. CONTRACTOR WILL HAVE PRIVATE UTILITY LOCATOR LOCATE ALL UTILITIES WITHIN THE CONSTRUCTION LIMITS NOT COVERED BY THE UTILITY PROTECTION CENTER.

10. THE CONTRACTOR SHALL IMMEDIATELY NOTIFY THE ENGINEER OF ANY DISCREPANCIES OR ERRORS THAT HE MAY DISCOVER IN THESE PLANS.

11. CONTRACTOR TO PROVIDE ALL NECESSARY BARRICADES, GUARDS, LIGHTS, AND OTHER INSTALLATIONS REQUIRED TO PROTECT PERSONS AND PROPERTY DURING THE ENTIRE CONSTRUCTION PROCESS.

12. ALL CONSTRUCTION MUST CONFORM TO THE APPROPRIATE CITY, COUNTY, AND STATE STANDARDS.

13. UNDERGROUND UTILITIES SERVING OR CROSSING THE PREMISES MAY EXIST THAT ARE NOT SHOWN. CRESCENT VIEW ENGINEERING IS UNABLE TO CERTIFY TO THE ACCURACY OR COMPLETENESS OF THE UTILITY INFORMATION SHOWN. ALL UNDERGROUND UTILITY LOCATIONS MUST BE FIELD VERIFIED PRIOR TO ANY CONSTRUCTION ACTIVITY BY THE UTILITY PROTECTION CENTER AT 1-800-282-7411 FOR RIGHT OF WAY AREA AND BY A PRIVATE UTILITY LOCATOR FOR UTILITIES NOT LOCATED WITHIN THE RIGHT OF WAY.

14. THE CONTRACTOR MUST OBTAIN ADDITIONAL "RIGHT OF WAY" PERMIT FOR ALL NECESSARY WORK DONE IN THE RIGHT OF

GRADING NOTES:

1. APPROVED EROSION CONTROL DEVICES MUST BE INSTALLED PRIOR TO ANY DETENTION BMP INSTALLATION (NOT PART OF THIS PLAN) SURVEY

3. SURVEY INFORMATION IS TAKEN FROM SURVEY PERFORMED BY SURVEY SYSTEMS ATLANTA, DATED 3-15-2021

4. DISCOVERY OF UNSUITABLE SOILS OR ROCK MUST BE IMMEDIATELY REPORTED TO THE OWNER AND ENGINEER. ALL EARTHWORK MUST NOT PROCEED AT THAT POINT UNTIL OWNER RELEASES THE CONTRACTOR TO PROCEED.

5. THE CONTRACTOR IS SPECIFICALLY CAUTIONED THAT THE LOCATION OF UTILITIES AND/OR ELEVATION OF EXISTING UTILITIES AS SHOWN ON THESE PLANS ARE BASED ON RECORDS PROVIDED TO THE ENGINEER INFORMATION SHOWN IS NOT TO BE RELIED ON AS BEING EXACT OR COMPLETE. THE CONTRACTOR MUST CALL THE APPROPRIATE UTILITY COMPANY AT LEAST 48 HOURS BEFORE ANY EXCAVATION TO REQUEST EXACT FIELD LOCATION OF UTILITIES.

6. CONTRACTOR SHALL FOLLOW ALL APPLICABLE SAFETY AND CONSTRUCTION PROCEDURES, ORDINANCES. CODES. AND STANDARDS.

7. CONTRACTOR SHALL CONTACT THE UTILITY LOCATOR AS REQUIRED BY GEORGIA LAW AND HAVE ALL UTILITIES MARKED PRIOR TO ANY CONSTRUCTION ACTIVITY. CONTRACTOR WILL HAVE PRIVATE UTILITY LOCATOR LOCATE ALL UTILITIES WITHIN THE CONSTRUCTION LIMITS NOT COVERED BY THE UTILITY PROTECTION CENTER.

8. ALL ELEVATIONS SHOWN ARE FINISHED GRADE.

9. THE APPROXIMATE LOCATION OF KNOWN UNDERGROUND UTILITIES HAVE BEEN SHOWN AS PROVIDED BY THE SURVEY. IT SHALL BE THE GENERAL CONTRACTOR'S RESPONSIBILITY TO FIELD VERIFY, LOCATE AND PROTECT ALL UTILITIES ON THE SITE. THE CONTRACTOR SHALL ALSO BE RESPONSIBLE FOR COORDINATING DEMOLITION, RELOCATION AND NEW UTILITY SERVICE WITH THE APPROPRIATE UTILITY. CONTRACTOR SHALL HIRE THEIR OWN UTILITY LOCATOR TO IDENTIFY ALL EXISTING UTILITIES WITHIN THE PROPOSED CONSTRUCTION AREA. ALL EXISTING SANITARY SEWER CONNECTIONS TO BE IDENTIFIED AND CONNECTED TO NEW SANITARY SEWER LINES.

10. BEFORE STARTING WORK CONTRACTOR SHALL MAKE SUCH EXPLORATIONS AND PROBES AS NECESSARY TO ASCERTAIN ANY ACTIVE UTILITY LINES AND MAKE SURE THESE UTILITIES CAN BE BROKEN OR CHANGED WITHOUT ANY DANGER OR DISRUPTION TO ANY NECESSARY SERVICE.

11. CONTRACTOR SHALL COMPLY TO THE FULLEST EXTENT WITH THE LATEST STANDARDS OF OSHA DIRECTIVES OR ANY OTHER AGENCY HAVING JURISDICTION FOR EXCAVATION AND TRENCHING PROCEDURES. THE CONTRACTOR SHALL SUPPORT SYSTEMS, SLOPING, BENCHING, AND OTHER MEANS OF PROTECTION. THIS TO INCLUDE, BUT IS NOT LIMITED TO ACCESS AND EGRESS FROM ALL EXCAVATION AND TRENCHING. CONTRACTOR IS RESPONSIBLE TO COMPLY WITH PERFORMANCE CRITERIA FOR OSHA.

ZONING CONFORMANCE:

R-4A (SINGLE FAMILY DETACHED) SITE ZONING:

7,500 SF MINIMUM LOT SIZE: FRONT SETBACK: 30 FEET

SIDE SETBACK: THERE SHALL BE TWO SIDE YARDS, ONE ON EACH SIDE OF THE MAIN BUILDING, EACH HAVING A WIDTH OF NOT LESS THAN 7 FT

REAR SETBACK: 15 FEET LOT FRONTAGE: 50 FEET SHALL NOT EXCEED 55%

LOT COVERAGE: MINIMUM PARKING: 1 SPACE PER DWELLING BUILDING HEIGHT: NO MORE THAN 35 FEET FLOOR AREA: SHALL NO EXCEED 0.65

LOT AREAS:

LOT AREA = 8,276 SF = 0.190 ACRES

PROPOSED IMPERVIOUS AREA = 2,050 SF = 0.047 ACRES

PROPOSED FFE: 863.00

PROPOSED GFFE: 862.50

SITE AREA = 8,276 SF FIRST LEVEL = 1,140 SQFTSECOND LEVEL = 1,367 SQFT

STRUCTURE GROSS HEATED SQUARE FEET (PER ARCHITECT)

= 2,507 SQ FT (TOTAL)

FLOOR AREA RATIO:

FLOOR AREA RATIO = 0.30 NO TREES TO BE IMPACTED BY NEW CONSTRUCTION

STATE WATER STATEMENT:

THIS PROPERTY IS NOT LOCATED INSIDE DESIGNATED F.I.A SPECIAL FLOOD HAZARD AREA AS PER THE FLOOD INSURANCE RATE MAP #13121C0228F, DATED SEPTEMBER 18, 2013.

THERE ARE WATERS OF THE STATE OF GEORGIA LOCATED ON OR WITHIN 200 FEET OF THE SITE. ALL APPROPRIATE STATE WATER BUFFERS ARE SHOWN ON THE SITE PLANS.

PROPOSED TREES / PLANTINGS:



" WHITE OAK (QUERCUS ALBA) — 2 QTY

3" BLACKGUM TUPELO (NYSSA SYLVATICA) - 1 QTY

TOTAL SITE ACRES = 0.190 ACRES TOTAL DISTURBED AREA = 0.095 ACRES

SIT


treet 17 Distri تّو

CVE PI # 21-277

 \mathcal{C}

SHEET NO.

SCALE: 1" = 20'

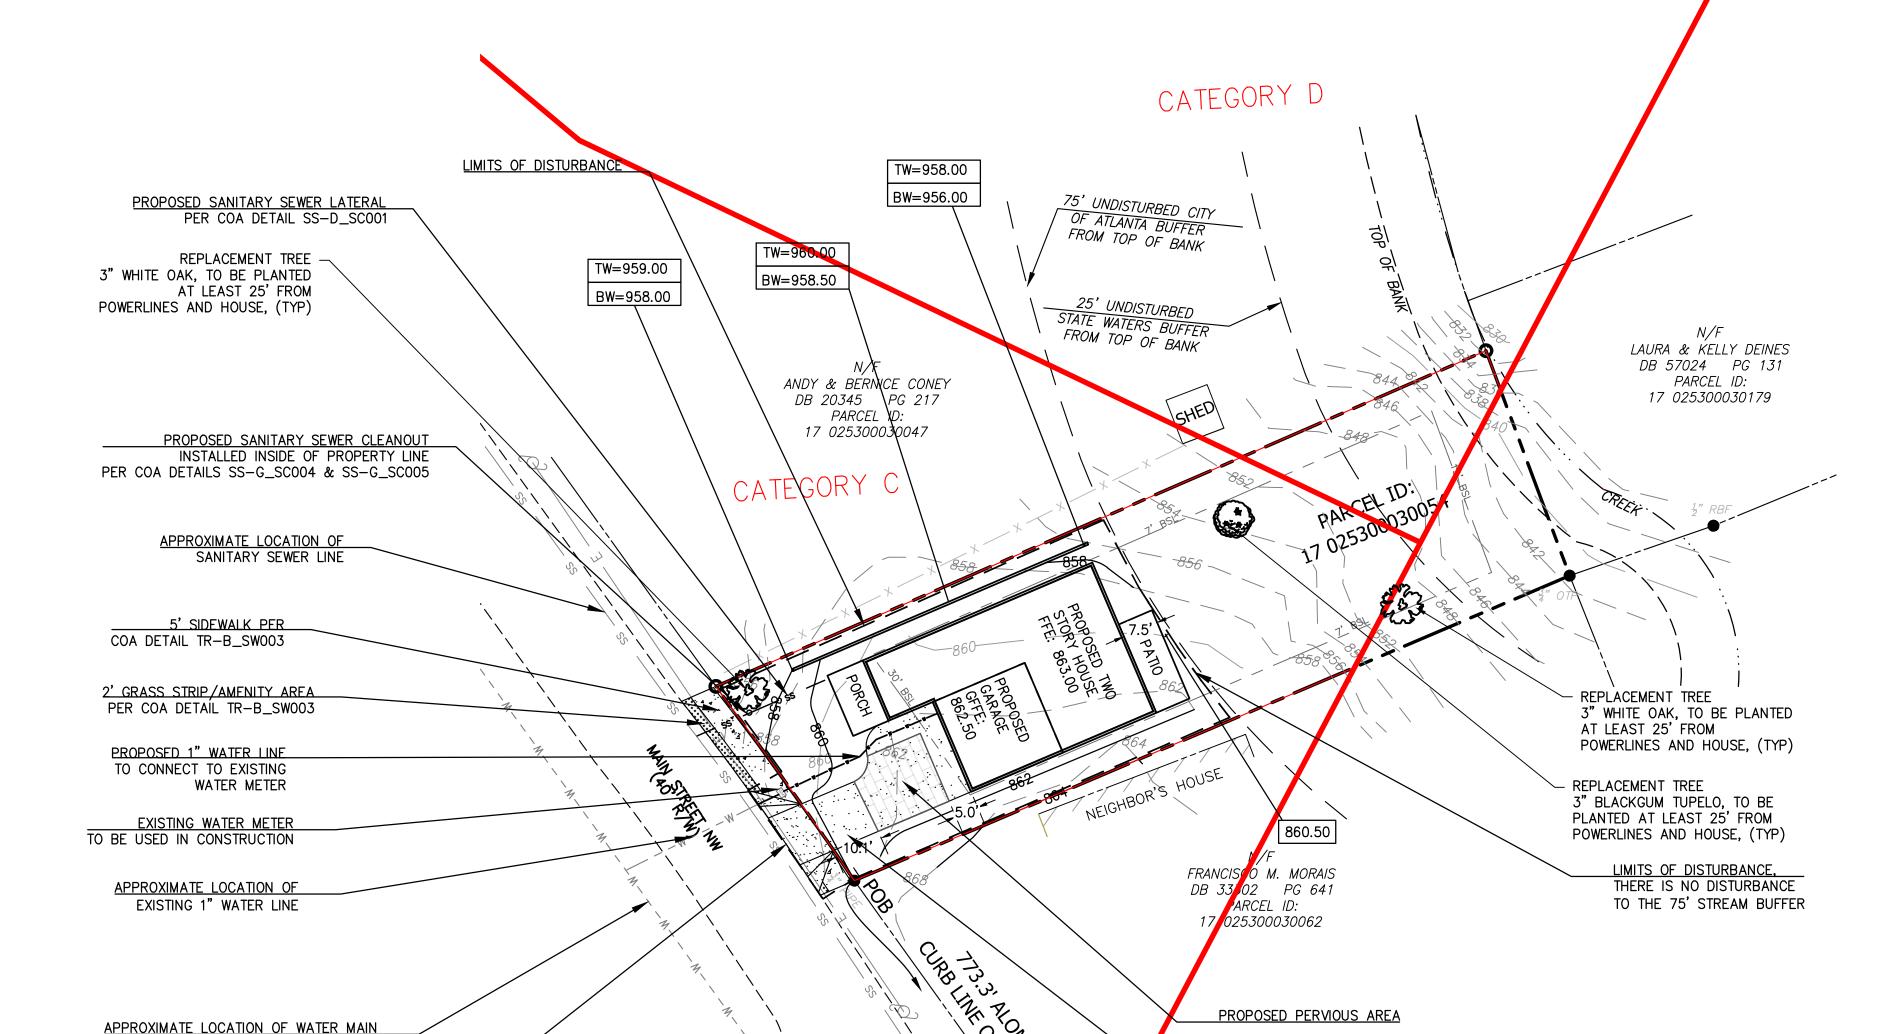

PROPOSED DRIVEWAY

Know what's **below**.

Call before you dis

ARC VULNERABILITY TABLE:

ARC VULNERABILITY	STUDY		
Category	D	C	ALLOWED DISTUDDED ADEA
Site Area (sf)	984	6307	ALLOWED DISTURBED AREA
			- 70% OF CATEGORY C
Allowed Disturbed Area (sf)	492	4415	- 50% OF CATEGORY D
Existing Disturbed Area (sf)	0	0	1
Proposed Disturbed Area (sf)	0	4268	ALLOWED IMPERVIOUS AREA
Remaining Disturbed Area (sf)	492	147	- 45% OF CATEGORY C
			- 30% OF CATEGORY D
Allowed Impervious Area (sf)	295	2838	SOM OF CATEGORY B
Existing Impervious Area (sf)	0	0	
Proposed Impervious Area (sf)	0	2373]
Remaining Impervious Area (sf)	295	465	1

DIRT STATEMENT:

75 CU YDS (ESTIMATED)

FILL: 105 CU YDS (ESTIMATED) HAUL VOLUMES: 30 CU YDS - TO BE HAULED ON SITE.

NET EARTHWORK VOLUMES ARE LESS THAN 500 CUBIC YARDS. THEREFORE, A HAUL ROUTE PERMIT IS NOT REQUIRED.

PROPOSED DRIVEWAY ENTRANC PER COA DETAIL TR-B_DR005

Proposed Impervious Area	SF
Proposed House	1141
Proposed Front Porch	109
Proposed Garage	423
Proposed Driveway	520
Proposed Back Patio	150
Proposed Wall	30
Total Proposed Impervious Area	2373
Proposed Lot Coverage	28.67%

PROPOSED LOT COVERAGE:

SITE NOTES:

- 1. THE SITE CONTAINS: 0.190 ACRES / 8,276 SF TOTAL DISTURBED ACREAGE: 0.095 ACRES
- 2. SITE ADDRESS: 2167 MAIN STREET NW, ATLANTA GA 30318
- SURVEY INFORMATION IS TAKEN FROM SURVEY PERFORMED BY C&A INVESTORS, LLC DATED 10-1-2021 TOPOGRAPHY INFORMATION TAKEN FROM FULTON COUNTY GIS
- 4. THIS PROPERTY IS NOT LOCATED INSIDE DESIGNATED F.I.A SPECIAL FLOOD HAZARD AREA AS PER THE FLOOD INSURANCE RATE MAP #13121C0228F, DATED SEPTEMBER 18, 2013
- THERE ARE NO KNOWN WETLANDS ON THE PROJECT SITE.
- THERE IS ONE KNOWN STREAMS LOCATED BEHIND THE PROPOSED HOUSE NEAR THE PROPERTY LINE. ALL ASSOCIATED STREAM BUFFERS AREAS ASSOCIATED WITH THE PROPERTY ARE SHOWN ONSITE.
- 7. TO THE BEST OF OUR KNOWLEDGE, THERE ARE NO CEMETERIES, ARCHITECTURAL, OR ARCHEOLOGICAL LANDMARKS THAT EXIST ON SITE. IN THE EVENT THAT THESE LANDMARKS ARE DISCOVERED DURING CONSTRUCTION, THE ENGINEER MUST BE CONTACTED IMMEDIATELY FOR REVIEW AND AMENDING THE
- THE EXISTING UTILITIES SHOWN ON THE PLANS ARE SHOWN FOR THE CONTRACTOR'S CONVENIENCE. THE ENGINEER ASSUMES NO RESPONSIBILITY FOR THE LOCATIONS, SIZES, MATERIALS, OR DEPTH FOR THE UTILITIES SHOWN OR THE UTILITIES WHICH MAY EXIST ON THE SITE BUT ARE NOT SHOWN. THE CONTRACTOR SHALL HAVE THE RESPONSIBILITY TO VERIFY THE LOCATION OF ALL UTILITIES SHOWN ON THE PLANS AND REPORT ANY DISCREPANCIES TO THE ENGINEER OF RECORD. THE CONTRACTOR SHALL ALSO HAVE THE RESPONSIBILITY BEFORE STARTING ANY WORK TO MAKE SUCH EXPLORATIONS AND PROBES NECESSARY TO ASCERTAIN ANY SEWER LINES, WATER SUPPLY LINES, GAS LINES, ELECTRICAL LINES, CABLE LINES, TELEPHONE
- CONTRACTOR SHALL CONTACT THE UTILITY LOCATOR AS REQUIRED BY GEORGIA LAW AND HAVE ALL UTILITIES MARKED PRIOR TO ANY CONSTRUCTION ACTIVITY. CONTRACTOR WILL HAVE PRIVATE UTILITY LOCATOR LOCATE ALL UTILITIES WITHIN THE CONSTRUCTION LIMITS NOT COVERED BY THE UTILITY PROTECTION CENTER.
- 10. THE CONTRACTOR SHALL IMMEDIATELY NOTIFY THE ENGINEER OF ANY DISCREPANCIES OR ERRORS THAT HE MAY DISCOVER IN THESE PLANS.
- 11. CONTRACTOR TO PROVIDE ALL NECESSARY BARRICADES, GUARDS, LIGHTS, AND OTHER INSTALLATIONS REQUIRED TO PROTECT PERSONS AND PROPERTY DURING THE ENTIRE CONSTRUCTION PROCESS.
- 12. ALL CONSTRUCTION MUST CONFORM TO THE APPROPRIATE CITY, COUNTY, AND STATE STANDARDS.
- 13. UNDERGROUND UTILITIES SERVING OR CROSSING THE PREMISES MAY EXIST THAT ARE NOT SHOWN. CRESCENT VIEW ENGINEERING IS UNABLE TO CERTIFY TO THE ACCURACY OR COMPLETENESS OF THE UTILITY INFORMATION SHOWN. ALL UNDERGROUND UTILITY LOCATIONS MUST BE FIELD VERIFIED PRIOR TO ANY CONSTRUCTION ACTIVITY BY THE UTILITY PROTECTION CENTER AT 1-800-282-7411 FOR RIGHT OF WAY AREA AND BY A PRIVATE UTILITY LOCATOR FOR UTILITIES NOT LOCATED WITHIN THE RIGHT OF WAY.
- 14. THE CONTRACTOR MUST OBTAIN ADDITIONAL "RIGHT OF WAY" PERMIT FOR ALL NECESSARY WORK DONE IN THE RIGHT OF WAY.

CITY OF ATLANTA GENERAL NOTES:

- COMPLETE PLANS: ALL PLANS SUBMITTED FOR PERMIT MUST BE COMPLETE AND PROVIDE ALL APPLICABLE ITEMS LISTED IN THIS CHECKLIST.
- 2. SURVEY: ALL PLANS FOR NEW BUILDINGS OR PROPOSED WORK WITHIN OR NEAR A STREAM BUFFER, FLOODPLAIN, WETLAND OR SEWER EASEMENT MUST INCLUDE A RECENT BOUNDARY AND TOPOLOGICAL SURVEY DRAWING SHOWING EXISTING CONDITIONS SIGNED, SEALED, AND DATED BY A GEORGIA REGISTERED LAND SURVEYOR. SUCH SURVEY IS HIGHLY RECOMMENDED FOR OTHER PROJECTS NEEDING
- SEALED PLANS: GRADING PLANS MUST BE SIGNED AND SEALED BY A GEORGIA REGISTERED ENGINEER, LAND SURVEYOR, ARCHITECT, LANDSCAPE ARCHITECT, OR OTHER QUALIFIED PROFESSIONAL AS APPROPRIATE. PLANS WITH DISTURBED AREA GREATER THAN 1.0 ACRE OR FOR NEW BUILDINGS OR PROPOSING WORK WITHIN OR NEAR A STREAM BUFFER. FLOODPLAIN OR WETLAND MUST INCLUDE THE CERTIFICATION OF THE GSWCC LEVEL II DESIGN PROFESSIONAL (NAME, NUMBER AND EXPIRATION DATE OF CERTIFICATE), WHO PREPARED THE EROSION, SEDIMENTATION AND POLLUTION CONTROL (ES&PC) PLAN.
- <u>DEMOLITION PLAN:</u> ALL PLANS FOR REDEVELOPMENT MUST INCLUDE A DEMOLITION PLAN, CLEARLY INDICATING ALL EXISTING STRUCTURES AND SITE FEATURES TO BE DEMOLISHED AND THOSE STRUCTURES AND SITE FEATURES THAT WILL REMAIN.

CONSTRUCTION AND FINAL INSPECTION:

- PRE-CONSTRUCTION MEETING: BEFORE STARTING ANY LAND DISTURBING ACTIVITIES, THE CONTRACTOR IS REQUIRED TO SCHEDULE A PRE-CONSTRUCTION MEETING WITH EROSION & SEDIMENT CONTROL. CALL 404-546-1305. FAILURE TO SCHEDULE MAY RESULT IN A STOP WORK ORDER OR PERMIT REVOCATION.
- 2. REVISIONS TO PERMITTED PLANS: REVISIONS TO PERMITTED PLANS MUST BE SUBMITTED THROUGH THE BUREAU OF BUILDINGS. FOR SITE DEVELOPMENT PURPOSES FOUR(4) SETS OF PLANS ARE REQUIRED; HOWEVER ADDITIONAL SETS OF PLANS MAY BE REQUIRED BY BUREAU OF BUILDINGS FOR OTHER AGENCY
- 3. FINAL STABILIZATION AND SIGN-OFF: FOLLOWING THE COMPLETION OR CESSATION OF LAND-DISTURBING ACTIVITIES AT A SITE, ALL UNPAVED AREAS AND AREAS NOT COVERED BY PERMANENT STRUCTURES SHALL BE UNIFORMLY COVERED (ONE-HUNDRED (100) PERCENT OF THE SOIL WITHIN THE DISTURBED AREA) WITH PERMANENT VEGETATION WITH A DENSITY OF SEVENTY (70) PERCENT OR GREATER, OR EQUIVALENT PERMANENT STABILIZATION MEASURES, INCLUDING, BUT NOT LIMITED TO, RIP RAP, GABIONS, PERMANENT MULCHES, OR GEOTEXTILES. A FINAL SIGN-OFF BY THE DEPARTMENT OF WATERSHED MANAGEMENT SHALL BE REQUIRED FIR ALL PROJECTS INVOLVING LAND-DISTURBING ACTIVITIES, AND SAID SIGN OFF SHALL OCCUR PRIOR TO THE ISSUANCE OF A CERTIFICATE OF OCCUPANCY OR THE RECORDING OF ANY FINAL PLAT. CALL 404-546-1305.

PERMITS AND BONDS:

- HAUL ROUTE: A HAUL ROUTE PERMIT IS REQUIRED FROM THE TRAFFIC AND TRANSPORTATION SECTION (404-330-6501) OF PUBLIC WORKS WHEN MORE THAN 500 CUBIC YARDS OF MATERIAL IS HAULED TO OR FROM THE SITE.
- 2. QUALIFIED CONTRACTOR:: A QUALIFIED CONTRACTOR PERMIT IS REQUIRED FROM THE TRAFFIC AND TRANSPORTATION SECTION (404-330-6501) OF PUBLIC WORKS FOR CONSTRUCTION OF NEW SEWER CONNECTION, SIDEWALKS, DRIVEWAY APRON OR OTHER WORK IN THE PUBLIC RIGHT OF WAY. QUALIFIED CONTRACTOR PERMITS REQUIRE PROOF OF AN IN-FORCE GENERAL LIABILITY INSURANCE POLICY IN THE AMOUNT OF \$3 MILLION, AND VALID BUSINESS LICENSE AND PAYMENT OF APPLICABLE FEES. THE CITY OF ATLANTA SHALL BE SHOWN AS THE CERTIFICATE HOLDER OF THE POLICY.

SEWERS:

- CONSTRUCTION OVER SEWERS: THERE IS NO PROPOSED CONSTRUCTION OF BUILDINGS AND/OR STRUCTURES OVER EXISTING AND/OR PROPOSED SEWERS OR WITHIN DRAINAGE EASEMENTS. ALL PROPOSED STRUCTURES ARE LOCATED COMPLETELY OUTSIDE ALL EASEMENT LIMITS. FOR EXISTING (FOR SEWERS DEEPER THAN 10 FEET, THE PROPOSED CONSTRUCTION PLANS MUST DEMONSTRATE THAT THE BOTTOM OF THE PROPOSED STRUCTURE'S FOOTING IS BELOW A LINE RUNNING AT A 1:1 SLOPE FROM THE BOTTOM OUTSIDE EDGE OF EXISTING SEWER).
- SEPTIC SYSTEMS: WHEN PUBLIC SEWER IS NOT AVAILABLE AND A SEPTIC SYSTEM IS PROPOSED FOR INSTALLATION OR RENOVATION THE PLANS MUST SHOW THE LOCATION OF THE SEPTIC TANK AND DRAIN FIELDS. A STAMPED, APPROVED COPY OF THE SEPTIC SYSTEM INSTALLATION PLAN AND A COPY OF THE APPLICABLE COUNTY HEALTH DEPARTMENT PERMIT MUST BE INCLUDED WITH THE BUILDING PERMIT APPLICATION. SUCH PLANS CANNOT BE REVIEWED OR APPROVED WITHOUT HEALTH DEPARTMENT


RELEASED FOR CONSTRUCTION


24 HOUR EMERGENCY CONTACT: AHJAI FORTUNE 504-234-7292

CITY OF ATLANTA SINGLE FAMILY CONSTRUCTION DOCUMENTS FOR:

2167 MAIN STREET NW

LAND LOT 142 DISTRICT 17 ATLANTA, FULTON COUNTY, GEORGIA

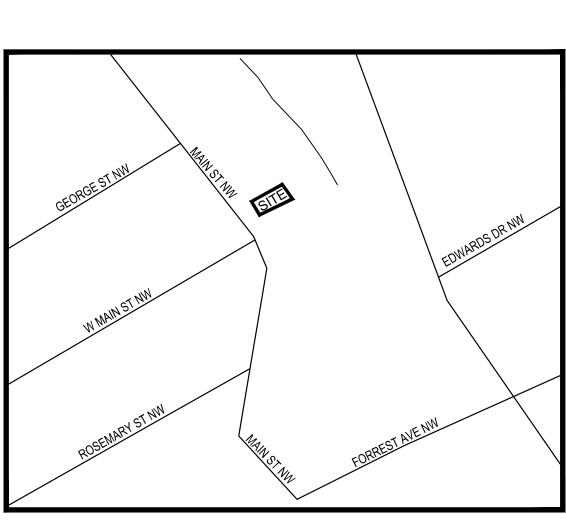

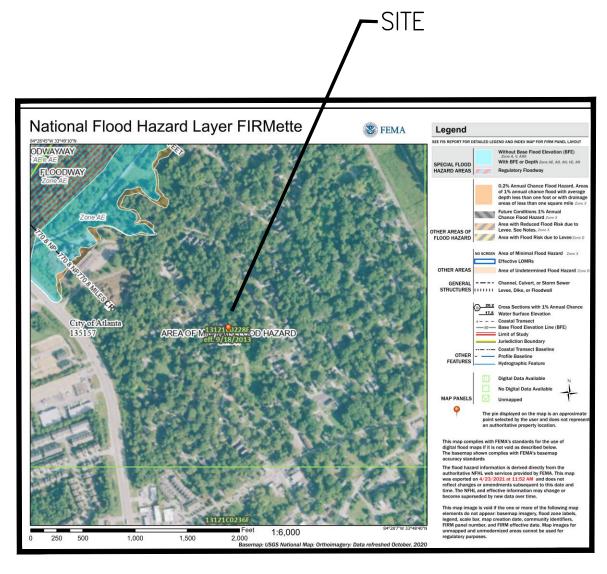

FLOOR AREA RATIO

STRUCTURE GROSS HEATED SQUARE FEET (PER ARCHITECT)

SITE AREA = 8,276 SF = 1,140 SQFT FIRST LEVEL SECOND LEVEL = 1,367 SQFT = 2,507 SQ FT (TOTAL)FLOOR AREA RATIO = 0.30

PROPOSED LOT COVERAGE:

Proposed Impervious Area	SF
Proposed House	1141
Proposed Front Porch	109
Proposed Garage	423
Proposed Driveway	520
Proposed Back Patio	150
Proposed Wall	30
Total Proposed Impervious Area	2373
Proposed Lot Coverage	28.67%

STATE WATER STATEMENT:

THIS PROPERTY IS NOT LOCATED INSIDE DESIGNATED F.I.A SPECIAL FLOOD HAZARD AREA AS PER THE FLOOD INSURANCE RATE MAP #13121C0228F, DATED SEPTEMBER

THERE ARE WATERS OF THE STATE OF GEORGIA LOCATED ON OR WITHIN 200 FEET OF THE SITE. ALL APPROPRIATE STATE WATER BUFFERS ARE SHOWN ON THE SITE PLANS.

> "I CERTIFY UNDER THE PENALTY OF LAW THAT THIS PLAN WAS PREPARED AFTER A SITE VISIT TO THE LOCATIONS DESCRIBED HEREIN BY MYSELF OR MY AUTHORIZED AGENT,



07-20-2025

CONSTRUCTION NARRATIVE:

THE PROPOSED PLANS CALL FOR THE CONSTRUCTION TO A SINGLE FAMILY HOME CONFORMING TO R-4A ZONING. ALL PHASED EROSION CONTROL BMPS ARE TO REMAIN IN PLACE UNTIL THE SITE IS 100% STABILIZED.

UTILITY LISTING:

ATLANTA GAS LIGHT COMPANY

CITY OF ATLANTA CITY OF ATLANTA

OWNER

AHJAI FORTUNE 2167 MAIN STREET ATLANTA, GA, 30318 504-234-7292 CANDAINVESTOR@GMAIL.COM

ENGINEERS

CRESCENT VIEW ENGINEERING, LLC 211 FRASIER ST,SE. MARIETTA GEORGIA 30060 678-324-8410

ZONING CONFORMANCE:

R-4A (SINGLE FAMILY DETACHED) SITE ZONING:

7,500 SF MINIMUM LOT SIZE: FRONT SETBACK: 30 FEET

SIDE SETBACK: THERE SHALL BE TWO SIDE YARDS, ONE ON EACH SIDE OF THE

MAIN BUILDING, EACH HAVING A WIDTH OF NOT LESS THAN 7 FT

REAR SETBACK: 15 FEET LOT FRONTAGE: 50 FEET

LOT COVERAGE: SHALL NOT EXCEED 55% 1 SPACE PER DWELLING MINIMUM PARKING: BUILDING HEIGHT: NO MORE THAN 35 FEET FLOOR AREA: SHALL NO EXCEED 0.65

LOT AREAS:

LOT AREA = 8.276 SF = 0.190 ACRES

PROPOSED IMPERVIOUS AREA = 2,050 SF = 0.047 ACRES

PROPOSED FFE: 863.00 PROPOSED GFFE: 862.50

CURRENT MANDATORY CODES AS ADOPTED BY DCA:

INTERNATIONAL BUILDING CODE, 2018 EDITION, WITH GEORGIA AMENDMENTS (2020)

INTERNATIONAL RESIDENTIAL CODE, 2018 EDITION, WITH GEORGIA AMENDMENTS (2020)

INTERNATIONAL FIRE CODE, 2018 EDITION (NO GEORGIA AMENDMENTS)

INTERNATIONAL PLUMBING CODE, 2018 EDITION, WITH GEORGIA AMENDMENTS (2020)

INTERNATIONAL MECHANICAL CODE, 2018 EDITION, WITH GEORGIA AMENDMENTS (2020)

INTERNATIONAL FUEL GAS CODE, 2018 EDITION, WITH GEORGIA AMENDMENTS (2020)

NATIONAL ELECTRICAL CODE, 2017 EDITION (NO GEORGIA AMENDMENTS)

INTERNATIONAL ENERGY CONSERVATION CODE, 2015 EDITION, WITH GEORGIA SUPPLEMENTS AND AMENDMENTS (2020)

INTERNATIONAL SWIMMING POOL AND SPA CODE, 2018 EDITION, WITH GEORGIA AMENDMENTS (2020)

FOR INFORMATION AND QUESTIONS REGARDING THE LIFE SAFETY CODE (NFPA 101) OR THE GEORGIA ACCESSIBILITY CODE PLEASE CONTACT THE STATE FIRE MARSHAL'S OFFICE.

CURRENT PERMISSIVE CODES AS ADOPTED BY DCA:

DISASTER RESILIENT BUILDING CODE IBC APPENDIX (2013)

DISASTER RESILIENT BUILDING CODE IRC APPENDIX (2013)


INTERNATIONAL PROPERTY MAINTENANCE CODE, 2012 EDITION, WITH GEORGIA AMENDMENTS (2015)

INTERNATIONAL EXISTING BUILDING CODE, 2012 EDITION, WITH GEORGIA AMENDMENTS (2015)

NATIONAL GREEN BUILDING STANDARD, 2008 EDITION, WITH GEORGIA AMENDMENTS (2011)

	SHEET LIST
SHEET NO.	SHEET TITLE
CV	COVER SHEET
SV	SURVEY
D-1	DEMO
C-1	SITE PLAN
C-2	STORMWATER PLAN
C-3	ES□PC PLAN
C-4	DETAILS


SIT

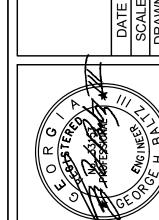

تو

CVE PI # 21-277

SHEET NO.

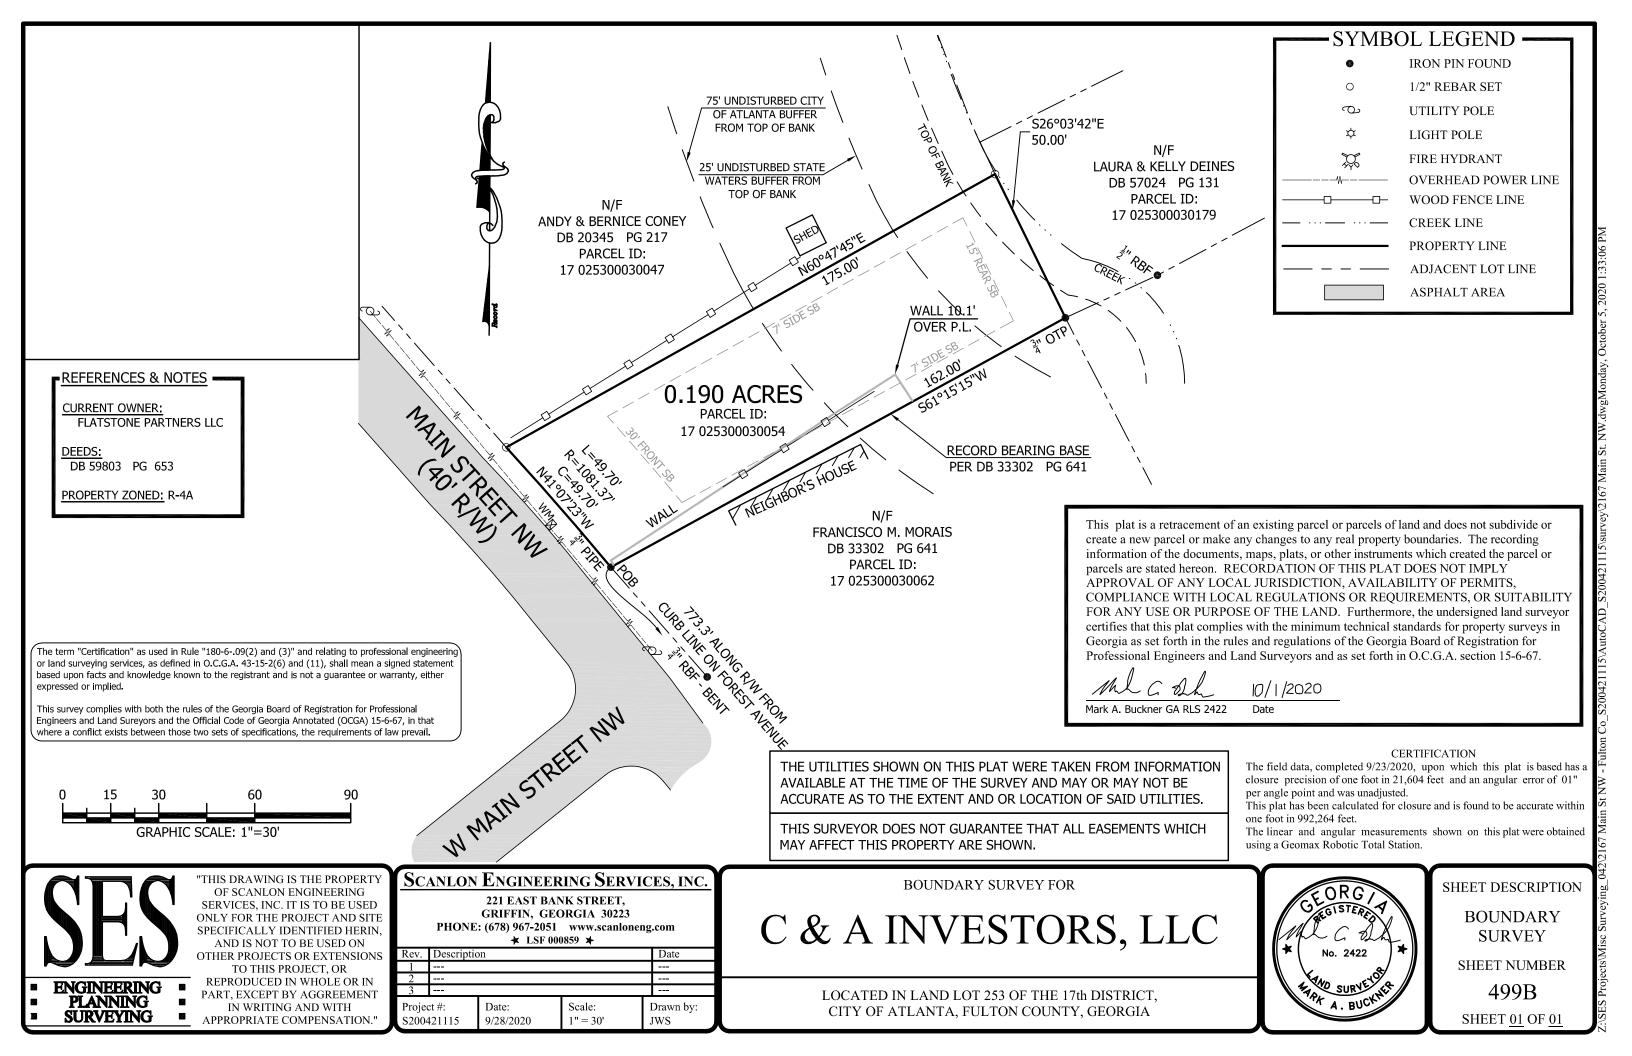

DB 57024 PG 131

PARCEL ID:

17 025300030179

CVE PI # 21-277

SHEET NO.

1. THE APPROXIMATE LOCATION OF KNOWN UNDERGROUND UTILITIES HAVE BEEN SHOWN AS PROVIDED BY THE SURVEY. IT SHALL BE THE GENERAL CONTRACTOR'S RESPONSIBILITY TO FIELD VERIFY, LOCATE AND PROTECT ALL UTILITIES ON THE SITE. THE CONTRACTOR SHALL ALSO BE RESPONSIBLE FOR COORDINATING DEMOLITION, RELOCATION AND NEW UTILITY SERVICE WITH THE APPROPRIATE UTILITY. CONTRACTOR SHALL HIRE THEIR OWN UTILITY LOCATOR TO IDENTIFY ALL

EXISTING UTILITIES WITHIN THE PROPOSED CONSTRUCTION AREA. ALL EXISTING SANITARY SEWER

2. CONTRACTOR SHALL IMMEDIATELY CONTACT OWNERS REPRESENTATIVE AND ENGINEER IF ANY DISCREPANCIES OR CONFLICTS ARE ENCOUNTERED.

CONNECTIONS TO BE IDENTIFIED AND CONNECTED TO NEW SANITARY SEWER LINES.

3. ALL WORK SHALL COMPLY WITH APPLICABLE FEDERAL, STATE AND LOCAL LAWS, ORDINANCES, STANDARDS OR CODES. ALL NECESSARY LICENSES OR PERMITS SHALL BE OBTAINED BY THE CONTRACTOR AT HIS EXPENSE UNLESS PREVIOUSLY STATED BY OWNER.

4. ALL CONSTRUCTION MUST CONFORM TO APPROPRIATE UTILITIES AND CITY STANDARDS.

5. CONTRACTOR SHALL PROVIDE ALL NECESSARY BARRICADES, SUFFICIENT LIGHTS, SIGNS, AND OTHER TRAFFIC CONTROL METHODS AS MAY BE NECESSARY FOR THE PROTECTION AND SAFETY OF THE PUBLIC. CONTRACTOR SHALL MAINTAIN THESE TRAFFIC CONTROL AND SAFETY METHODS THROUGHOUT CONSTRUCTION OF THIS PROJECT.

6. BEFORE STARTING WORK CONTRACTOR SHALL MAKE SUCH EXPLORATIONS AND PROBES AS NECESSARY TO ASCERTAIN ANY ACTIVE UTILITY LINES AND MAKE SURE THESE UTILITIES CAN BE BROKEN OR CHANGED WITHOUT ANY DANGER OR DISRUPTION TO ANY NECESSARY SERVICE.

7. FOR ALL ITEMS NOTED TO BE REMOVED - REMOVE NOT ONLY THE ABOVE GROUND ELEMENTS, BUT ALL UNDERGROUND ELEMENTS AS WELL INCLUDING BUT NOT NECESSARILY LIMITED TO: FOUNDATIONS, GRAVEL FILLS, TREE ROOTS, OLD PIPE, ETC.

8. BACKFILL ALL EXCAVATIONS RESULTING FROM THE DEMOLITION WORK TO MEET THE REQUIREMENTS AND INSTRUCTIONS OF THE PROJECT GEOTECHNICAL ENGINEER.

9. DEMOLITION AND SITE PLANS HAVE BEEN PREPARED TO IDENTIFY MAJOR DEMOLITION ITEMS. CONTRACTOR TO PERFORM SITE VISIT PRIOR TO PRICING TO IDENTIFY ALL DEMOLITION ITEMS AS WELL AS IDENTIFYING ITEMS TO SALVAGE FOR OWNER.

10. CONTRACTOR SHALL PROTECT ALL EXISTING UTILITIES & ITEMS TO REMAIN.

11. CONTRACTOR SHALL BE RESPONSIBLE FOR CONSTRUCTION ACTIVITIES DAMAGE TO EXISTING STRUCTURE DURING CONSTRUCTION.

12. CONTRACTOR SHALL COORDINATE WITH OWNER/OWNER REPRESENTATIVE ALL PHASES OF CONSTRUCTION AND UTILITY CONSTRUCTION TO MAKE SURE ACCESS, HOURS OF OPERATION, AND UTILITY INTERRUPTION DO NOT INTERFERE WITH OWNER'S NEEDS.

13. LIMITS OF DEMOLITION OF CURB AND GUTTER, CONCRETE SIDEWALKS, SHALL BE TO THE NEAREST CONSTRUCTION JOINT. REPAIR WORK SHALL ALSO BE TO THE NEAREST JOINT.

14. CONTRACTOR SHALL BE RESPONSIBLE FOR DEMOLITION AND/OR REMOVAL OF ALL ITEMS IN THE AREA OF NEW CONSTRUCTION.

15. CONTRACTOR SHALL BE RESPONSIBLE FOR PROPER DISPOSAL OF ALL ITEMS AND CONSTRUCTION DEBRIS IN ACCORDANCE WITH ALL FEDERAL, STATE AND LOCAL CODES.

16. CONTRACTOR SHALL COORDINATE A MEETING ON SITE WITH THE OWNER/OWNER REPRESENTATIVE TO REVIEW ALL ELEMENTS OF DEMOLITION AND IDENTIFY ALL ITEMS TO BE SALVAGED.

17. CONTRACTOR SHALL REPAIR AT HIS/HER EXPENSE, DAMAGE TO ANY NEW OR EXISTING SITE FEATURES CAUSED BY CONSTRUCTION ACTIVITIES.

18. ALL EXISTING UTILITIES LOCATED UNDER PROPOSED BUILDING FOUNDATIONS ARE TO BE RE-ROUTED AROUND & AWAY FROM NEW BUILDING FOOTPRINT.

19. T.B.R = TO BE REMOVED

GENERAL DEMOLITION SCOPE:


BE ADVISED THIS IS NOT AN EXHAUSTIVE LIST OF DEMOLITION ITEMS. CONTRACTOR SHALL BECOME FAMILIAR WITH THE SITE AND THE COMPLETE DESIGN INTENT OF THE CONSTRUCTION DOCUMENTS. ANY QUESTIONS, CONCERNS, OR IDEAS CONCERNING THE INTENT OR EXECUTION OF THE DESIGN DOCUMENTS MUST BE BROUGHT TO THE OWNER BEFORE PREPARING ANY BIDS OR BEFORE PERFORMING ANY CONSTRUCTION ACTIVITY.

1) REMOVE EXISTING WALL - REMOVAL OF THE WALL IN THE STREAM BUFFER WILL BE DONE BY HAND

ANY ITEMS LOCATED WITHIN EXISTING TREE CRITICAL ROOT ZONE ARE TO BE REMOVED BY HAND OR HAND MACHINERY.

EXISTING LOT COVERAGE:

Existing Impervious Area	<u>SF</u>
Exisitng Wall	120
Total Existing Impervious Area	120
Existing Lot Coverage	1.45%

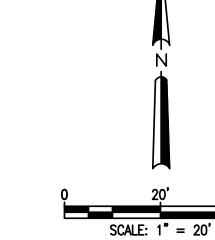



75' UNDISTURBED CITY OF ATLANTA BUFFER FROM TOP OF BANK LIMITS OF DISTURBANCE 25' UNDISTURBED STATE WATERS BUFFER FROM TOP OF BANK LAURA & KELLY DEINES ANDY & BERNICE CONEY DB 20345 PG 217 PARCEL ID: 17 025300030047 FRANCISCÓ M. MORAIS DB 33302 PG 641 PARCEL ID: 17 025300030062

SITE ADDRESS: 2167 MAIN STREET NW, ATLANTA GA 30318

SURVEY INFORMATION IS TAKEN FROM SURVEY PERFORMED BY C&A INVESTORS, DATED 9-28-20

TOPOGRAPHY INFORMATION TAKEN FROM FULTON COUNTY GIS

THIS PROPERTY IS NOT LOCATED INSIDE DESIGNATED F.I.A SPECIAL FLOOD HAZARD AREA AS PER THE FLOOD INSURANCE RATE MAP #13121C0228F, DATED SEPTEMBER 18, 2013

THERE ARE NO KNOWN WETLANDS ON THE PROJECT SITE.

THERE ARE NO KNOWN STREAMS, ALL ASSOCIATED STREAM BUFFERS AREAS ASSOCIATED WITH THE PROPERTY ARE SHOWN ONSITE.

TO THE BEST OF OUR KNOWLEDGE, THERE ARE NO CEMETERIES, ARCHITECTURAL, OR ARCHEOLOGICAL LANDMARKS THAT EXIST ON SITE. IN THE EVENT THAT THESE LANDMARKS ARE DISCOVERED DURING CONSTRUCTION, THE ENGINEER MUST BE CONTACTED IMMEDIATELY FOR REVIEW AND AMENDING THE CONSTRUCTION PLANS.

THE EXISTING UTILITIES SHOWN ON THE PLANS ARE SHOWN FOR THE CONTRACTOR'S CONVENIENCE. THE ENGINEER ASSUMES NO RESPONSIBILITY FOR THE LOCATIONS, SIZES, MATERIALS, OR DEPTH FOR THE UTILITIES SHOWN OR THE UTILITIES WHICH MAY EXIST ON THE SITE BUT ARE NOT SHOWN. THE CONTRACTOR SHALL HAVE THE RESPONSIBILITY TO VERIFY THE LOCATION OF ALL UTILITIES SHOWN ON THE PLANS AND REPORT ANY DISCREPANCIES TO THE ENGINEER OF RECORD. THE CONTRACTOR SHALL ALSO HAVE THE RESPONSIBILITY BEFORE STARTING ANY WORK TO MAKE SUCH EXPLORATIONS AND PROBES NECESSARY TO ASCERTAIN ANY SEWER LINES, WATER SUPPLY LINES, GAS LINES, ELECTRICAL LINES, CABLE LINES, TELEPHONE LINES, OR OTHER UTILITY LINE.

CONTRACTOR SHALL CONTACT THE UTILITY LOCATOR AS REQUIRED BY GEORGIA LAW AND HAVE ALL UTILITIES MARKED PRIOR TO ANY CONSTRUCTION ACTIVITY. CONTRACTOR WILL HAVE PRIVATE UTILITY LOCATOR LOCATE ALL UTILITIES WITHIN THE CONSTRUCTION LIMITS NOT COVERED BY THE UTILITY PROTECTION CENTER.

10. THE CONTRACTOR SHALL IMMEDIATELY NOTIFY THE ENGINEER OF ANY DISCREPANCIES OR ERRORS THAT HE MAY DISCOVER IN THESE PLANS.

11. CONTRACTOR TO PROVIDE ALL NECESSARY BARRICADES, GUARDS, LIGHTS, AND OTHER INSTALLATIONS REQUIRED TO PROTECT PERSONS AND PROPERTY DURING THE ENTIRE CONSTRUCTION PROCESS.

12. ALL CONSTRUCTION MUST CONFORM TO THE APPROPRIATE CITY, COUNTY, AND STATE STANDARDS.

13. UNDERGROUND UTILITIES SERVING OR CROSSING THE PREMISES MAY EXIST THAT ARE NOT SHOWN. CRESCENT VIEW ENGINEERING IS UNABLE TO CERTIFY TO THE ACCURACY OR COMPLETENESS OF THE UTILITY INFORMATION SHOWN. ALL UNDERGROUND UTILITY LOCATIONS MUST BE FIELD VERIFIED PRIOR TO ANY CONSTRUCTION ACTIVITY BY THE UTILITY PROTECTION CENTER AT 1-800-282-7411 FOR RIGHT OF WAY AREA AND BY A PRIVATE UTILITY LOCATOR FOR UTILITIES NOT LOCATED WITHIN THE RIGHT OF WAY.

14. THE CONTRACTOR MUST OBTAIN ADDITIONAL "RIGHT OF WAY" PERMIT FOR ALL NECESSARY WORK DONE IN THE RIGHT OF

GRADING NOTES:

1. APPROVED EROSION CONTROL DEVICES MUST BE INSTALLED PRIOR TO ANY DETENTION BMP INSTALLATION (NOT PART OF THIS PLAN) SURVEY

3. SURVEY INFORMATION IS TAKEN FROM SURVEY PERFORMED BY SURVEY SYSTEMS ATLANTA, DATED 3-15-2021

4. DISCOVERY OF UNSUITABLE SOILS OR ROCK MUST BE IMMEDIATELY REPORTED TO THE OWNER AND ENGINEER. ALL EARTHWORK MUST NOT PROCEED AT THAT POINT UNTIL OWNER RELEASES THE CONTRACTOR TO PROCEED.

5. THE CONTRACTOR IS SPECIFICALLY CAUTIONED THAT THE LOCATION OF UTILITIES AND/OR ELEVATION OF EXISTING UTILITIES AS SHOWN ON THESE PLANS ARE BASED ON RECORDS PROVIDED TO THE ENGINEER INFORMATION SHOWN IS NOT TO BE RELIED ON AS BEING EXACT OR COMPLETE. THE CONTRACTOR MUST CALL THE APPROPRIATE UTILITY COMPANY AT LEAST 48 HOURS BEFORE ANY EXCAVATION TO REQUEST EXACT FIELD LOCATION OF UTILITIES.

6. CONTRACTOR SHALL FOLLOW ALL APPLICABLE SAFETY AND CONSTRUCTION PROCEDURES, ORDINANCES. CODES. AND STANDARDS.

7. CONTRACTOR SHALL CONTACT THE UTILITY LOCATOR AS REQUIRED BY GEORGIA LAW AND HAVE ALL UTILITIES MARKED PRIOR TO ANY CONSTRUCTION ACTIVITY. CONTRACTOR WILL HAVE PRIVATE UTILITY LOCATOR LOCATE ALL UTILITIES WITHIN THE CONSTRUCTION LIMITS NOT COVERED BY THE UTILITY PROTECTION CENTER.

8. ALL ELEVATIONS SHOWN ARE FINISHED GRADE.

9. THE APPROXIMATE LOCATION OF KNOWN UNDERGROUND UTILITIES HAVE BEEN SHOWN AS PROVIDED BY THE SURVEY. IT SHALL BE THE GENERAL CONTRACTOR'S RESPONSIBILITY TO FIELD VERIFY, LOCATE AND PROTECT ALL UTILITIES ON THE SITE. THE CONTRACTOR SHALL ALSO BE RESPONSIBLE FOR COORDINATING DEMOLITION, RELOCATION AND NEW UTILITY SERVICE WITH THE APPROPRIATE UTILITY. CONTRACTOR SHALL HIRE THEIR OWN UTILITY LOCATOR TO IDENTIFY ALL EXISTING UTILITIES WITHIN THE PROPOSED CONSTRUCTION AREA. ALL EXISTING SANITARY SEWER CONNECTIONS TO BE IDENTIFIED AND CONNECTED TO NEW SANITARY SEWER LINES.

10. BEFORE STARTING WORK CONTRACTOR SHALL MAKE SUCH EXPLORATIONS AND PROBES AS NECESSARY TO ASCERTAIN ANY ACTIVE UTILITY LINES AND MAKE SURE THESE UTILITIES CAN BE BROKEN OR CHANGED WITHOUT ANY DANGER OR DISRUPTION TO ANY NECESSARY SERVICE.

11. CONTRACTOR SHALL COMPLY TO THE FULLEST EXTENT WITH THE LATEST STANDARDS OF OSHA DIRECTIVES OR ANY OTHER AGENCY HAVING JURISDICTION FOR EXCAVATION AND TRENCHING PROCEDURES. THE CONTRACTOR SHALL SUPPORT SYSTEMS, SLOPING, BENCHING, AND OTHER MEANS OF PROTECTION. THIS TO INCLUDE, BUT IS NOT LIMITED TO ACCESS AND EGRESS FROM ALL EXCAVATION AND TRENCHING. CONTRACTOR IS RESPONSIBLE TO COMPLY WITH PERFORMANCE CRITERIA FOR OSHA.

ZONING CONFORMANCE:

R-4A (SINGLE FAMILY DETACHED) SITE ZONING:

7,500 SF MINIMUM LOT SIZE: FRONT SETBACK: 30 FEET

SIDE SETBACK: THERE SHALL BE TWO SIDE YARDS, ONE ON EACH SIDE OF THE MAIN BUILDING, EACH HAVING A WIDTH OF NOT LESS THAN 7 FT

REAR SETBACK: 15 FEET LOT FRONTAGE: 50 FEET SHALL NOT EXCEED 55%

LOT COVERAGE: MINIMUM PARKING: 1 SPACE PER DWELLING BUILDING HEIGHT: NO MORE THAN 35 FEET FLOOR AREA: SHALL NO EXCEED 0.65

LOT AREAS:

LOT AREA = 8,276 SF = 0.190 ACRES

PROPOSED IMPERVIOUS AREA = 2,050 SF = 0.047 ACRES

PROPOSED FFE: 863.00

PROPOSED GFFE: 862.50

SITE AREA = 8,276 SF FIRST LEVEL = 1,140 SQFTSECOND LEVEL = 1,367 SQFT

STRUCTURE GROSS HEATED SQUARE FEET (PER ARCHITECT)

= 2,507 SQ FT (TOTAL)

FLOOR AREA RATIO:

FLOOR AREA RATIO = 0.30 NO TREES TO BE IMPACTED BY NEW CONSTRUCTION

STATE WATER STATEMENT:

THIS PROPERTY IS NOT LOCATED INSIDE DESIGNATED F.I.A SPECIAL FLOOD HAZARD AREA AS PER THE FLOOD INSURANCE RATE MAP #13121C0228F, DATED SEPTEMBER 18, 2013.

THERE ARE WATERS OF THE STATE OF GEORGIA LOCATED ON OR WITHIN 200 FEET OF THE SITE. ALL APPROPRIATE STATE WATER BUFFERS ARE SHOWN ON THE SITE PLANS.

PROPOSED TREES / PLANTINGS:



" WHITE OAK (QUERCUS ALBA) — 2 QTY

3" BLACKGUM TUPELO (NYSSA SYLVATICA) - 1 QTY

TOTAL SITE ACRES = 0.190 ACRES TOTAL DISTURBED AREA = 0.095 ACRES

SIT


treet 17 Distri تّو

CVE PI # 21-277

 \mathcal{C}

SHEET NO.

SCALE: 1" = 20'

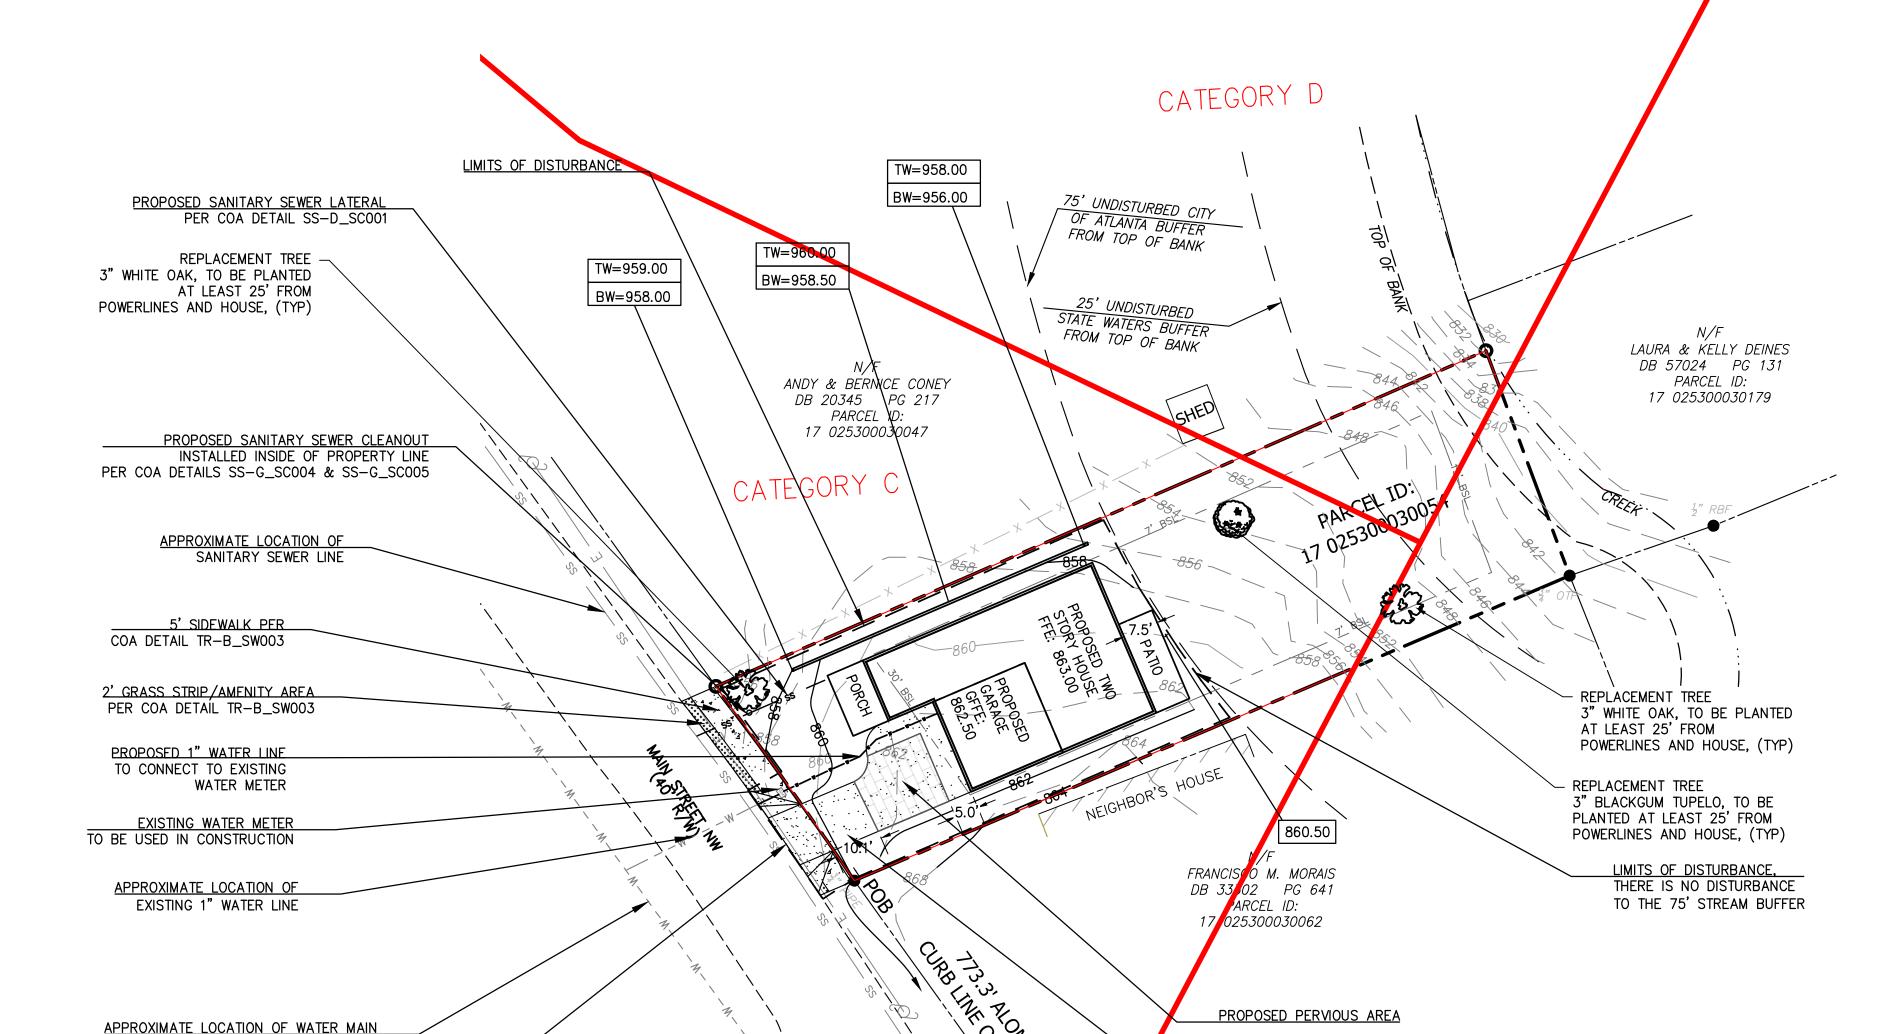

PROPOSED DRIVEWAY

Know what's **below**.

Call before you dis

ARC VULNERABILITY TABLE:

ARC VULNERABILITY	STUDY		
Category	D	C	ALLOWED DISTUDDED ADEA
Site Area (sf)	984	6307	ALLOWED DISTURBED AREA
			- 70% OF CATEGORY C
Allowed Disturbed Area (sf)	492	4415	- 50% OF CATEGORY D
Existing Disturbed Area (sf)	0	0	1
Proposed Disturbed Area (sf)	0	4268	ALLOWED IMPERVIOUS AREA
Remaining Disturbed Area (sf)	492	147	- 45% OF CATEGORY C
			- 30% OF CATEGORY D
Allowed Impervious Area (sf)	295	2838	SOM OF CATEGORY B
Existing Impervious Area (sf)	0	0	
Proposed Impervious Area (sf)	0	2373]
Remaining Impervious Area (sf)	295	465	1

DIRT STATEMENT:

75 CU YDS (ESTIMATED)

FILL: 105 CU YDS (ESTIMATED) HAUL VOLUMES: 30 CU YDS - TO BE HAULED ON SITE.

NET EARTHWORK VOLUMES ARE LESS THAN 500 CUBIC YARDS. THEREFORE, A HAUL ROUTE PERMIT IS NOT REQUIRED.

PROPOSED DRIVEWAY ENTRANC PER COA DETAIL TR-B_DR005

Proposed Impervious Area	SF
Proposed House	1141
Proposed Front Porch	109
Proposed Garage	423
Proposed Driveway	520
Proposed Back Patio	150
Proposed Wall	30
Total Proposed Impervious Area	2373
Proposed Lot Coverage	28.67%

PROPOSED LOT COVERAGE:

DOWNSPOUT AND PRETREATMENT

THE DOWNSPOUT AND FILTER / OVERFLOW SYSTEM OF CHOICE OR BRAND CAN BE CHOSEN BY THE OWNER / CONTRACTOR AS LONG AS THE PAVERS MEETS THE CITY OF ATLANTA REQUIREMENTS.

DOWNSPOUT MAINTENANCE

- INSPECT DOWNSPOUTS AND CLEANOUTS REMOVING ACCUMULATED LEAVES AND DEBRIS, CLEANING LEAF REMOVAL SYSTEM(S).
- IF APPLICABLE, INSPECT PRETREATMENT DEVICES FOR SEDIMENT ACCUMULATION. ENSURE THAT IT IS CLEAR OF DEBRIS
- INSPECT FOLLOWING A LARGE RAINFALL EVENT TO INSURE OVERFLOW IS OPERATING AND FLOW IS NOT CAUSING PROBLEMS. ROUTINE MAINTENANCE INCLUDES WEEDING, AND SMALL SEDIMENT REMOVAL. (MAINTENANCE SCHEDULE TO BE CHOSEN NY OWNER)
- PESTICIDES SHOULD NOT BE USED IN GREEN INFRASTRUCTURE.

INSPECT AFTER A HEAVY RAINFALL. IF STANDING WATER PERSISTS BEYOND 36 HOURS,

PERVIOUS PAVERS CONSTRUCTION SEQUENCE

- ANY UTILITY PIPES BELOW OR CROSSING AREA SHOULD BE CONSIDERED AND INSTALLED AT FINAL ELEVATION BEFORE GRAVEL AND PIPE INSTALLATION
- EXCAVATE CAREFULLY TO AVOID COMPACTING SOILS AT THE BOTTOM OF THE TRENCH SYSTEM. LEVEL THE BOTTOM AS MUCH AS POSSIBLE TO MAXIMIZE THE INFILTRATION AREA PER RUNOFF REDUCTION REQUIREMENTS (ON THIS PAGE).
- MEASURE ELEVATION AND LAY OUT THE TRENCH AREA AS REQUIRED PER TORPEDO / LEVEL
- IMPERVIOUS BARRIERS TO BE INSTALLED ALONG TRENCH EDGE PER DETAIL SPECIFICATIONS CREATE AN OVERFLOW AT LEAST 10 FEET FROM ANY PROPERTY LINE AND INSURE IT IS PROTECTED FROM EROSION.

THE LANDSCAPED AREA BY THE PAVERS AREA BE TO BE PLANTED WITH MANAGED TURF OR OTHER HERBACEOUS VEGETATION. GRASS OR VEGITATION TB BE CUT AND COLLECTED. IF AREA IS BLOWN DEBRIS IS NOT TO BLOWN INTO AREA OF PERVIOUS PAVERS.

<u>MAINTENANCE</u>

- MONTHLY •• ENSURE THAT CONTRIBUTING AREA, FACILITY AND INLETS ARE CLEAR OF DEBRIS.
- •• REMOVE SEDIMENT AND OIL/GREASE FROM PRETREATMENT DEVICES, AS WELL AS OVERFLOW STRUCTURES.
- •• MOW GRASS FILTER STRIPS SHOULD BE MOWED AS NECESSARY. REMOVE GRASS CLIPPINGS.

- •• CHECK OBSERVATION WELLS FOLLOWING 3 DAYS OF DRY WEATHER. FAILURE TO PERCOLATE WITHIN THIS TIME PERIOD INDICATES CLOGGING.
- •• INSPECT PRETREATMENT DEVICES AND DIVERSION STRUCTURES FOR SEDIMENT BUILD-UP AND STRUCTURAL DAMAGE.
- •• REMOVE TREES THAT START TO GROW IN THE VICINITY OF THE TRENCH.REPLACE PEA GRAVEL/TOPSOIL/GRASSING AND TOP SURFACE FILTER FABRIC (WHEN CLOGGED).

PAVER JOINT, SPACE PAVERS

PER MANUFACTURER

CIRCLE ONE OR MORE OPTIONS USED A B C D

PRETREATMENT OPTIONS DETAIL

PERMEABLE PAVER

SPECIFICATIONS

PAGE 1 OF 2

November 2012

GUIDELINES

AS NEEDED

- •• PERFORM TOTAL REHABILITATION OF THE PAVERS TO MAINTAIN DESIGN STORAGE CAPACITY.
- •• EXCAVATE PAVERS TO EXPOSE CLEAN SOIL AND REBUILD UPON FAILURE.

PAVER JOINT, SPACE PAVERS PER MANUFACTURER GUIDELINES

PAVER

CONSTRUCTION STEPS:

specifications.

until filled and even.

CITY OF ATLANTA

DEPARTMENT OF WATERSHED

MANAGEMENT

8 STONE OR PEA GRAVEL IN JOINTS

EXISTING GRADE

- PERMEABLE FILTER FABRIC

CLEAN AND WASHED ON-SITE

-MIN. 3"

TYPICAL COMPONENTS (ATTACH MANUFACTURER'S SPECIFICATIONS)

1. Review potential paver areas and layout. Pavers should slope less than 6% away from the structure and

2. Measure the area draining to the pavers and determine required paver area from the table on the next

3. If soil is a concern perform infiltration test according to Appendix A. If the rate is less than 0.25 in/hr this

method cannot be used. If the rate is more than 0.50 in/hr the pave area may be decreased 10% for

should <u>not</u> be located: (1) above an area with a water table or bedrock less than two feet below the

#8 STONE OR PEA GRAVEL BEDDING COURSE

-UNCOMPACTED NATIVE SUBGRADE SCARIFY 3"

trench bottom; (2) over other utility lines; or, (3) above a septic field.

page based on the depth of the lower stone storage layer.

every 0.50 in/hr infiltration rate increase above 0.50

4. Excavate area to appropriate depth and scarify soil to

5. Place, level and compact gravel to planned depth in

no more than 6" lifts. Three inch minimum depth.

6. Place, level and compact #8 stone or pea gravel

7. Lay paving stone one at a time or using mechanical

placement as applicable. Cut stone at edges to fit.

9. Sweep more #8 stone or pea gravel into stone joints

10. Cut and route downspouts or other rainwater delivery

NAME/ADDRESS:

components, leaf screen option(s) chosen (circle

selected options in Pretreatment Options Detail

bedding layer. Two inch minimum depth.


8. Install edge restraints per manufacturer's

figure). Strap and support as needed.

#57 STONE BASE COURSE, DELIVERED

SITE AREAS:

TOTAL SITE ACRES = 0.190 ACRES TREATED IMPERVIOUS AREA = 2,050 SF TOTAL DISTURBED AREA = 0.095 ACRES

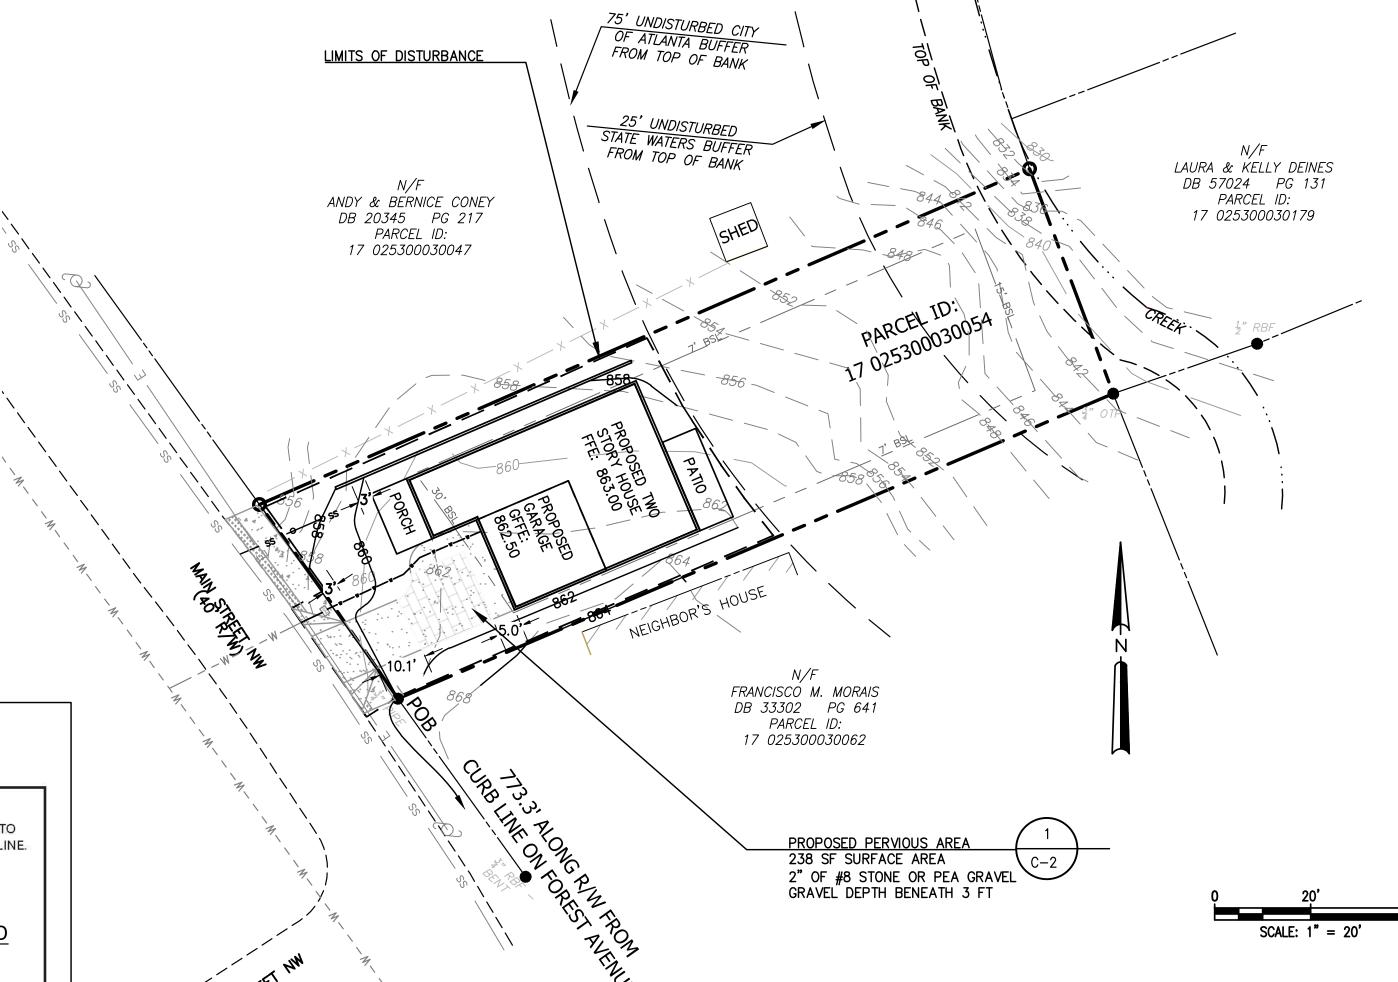

SKETCH LAYOUT

PROVIDE PLAN AND ELEVATION VIEWS OF PERVIOUS PAVER AND HOUSE SHOWING ROOF AREA DIRECTED TO PAVERS AND KEY DIMENSIONS, CONNECTIONS AND ANY APPLICABLE OVERFLOW RELATIVE TO PROPERTY LINE. ATTACH MANUFACTURER'S SPECIFICATIONS IF APPLICABLE.

FOR 2,373 OF IMPERVIOUS AREA AT MAIN STREET IS DESIGNED TO BE TREATED IN PERVIOUS PAVERS IN THE DRIVEWAY.

THE PAVERS AREA IS 238 SF WHICH IS AT LEAST 5 FT FROM THE THE HOUSE FOUNDATION AND 10 FEET FROM THE PROPERTY LINE.

SIZING CALCULATION:

Contributing Drainage Area	Depth of Lower Stone Storage Layer (inches)					
	3	4	5	6	8	
(square feet)	Area of Pavers (square feet)					
100	54	45	39	34	27	
500	280	230	200	170	140	
1000	550	460	390	340	280	
2000	1090	910	780	680	550	
3000	1630	1360	1170	1020	820	
4000	2180	1810	1560	1360	1090	
5000	2720	2270	1940	1700	1360	

MEASURE CONTRIBUTING DRAINAGE AREA AND READ AREA FOR GIVEN MEDIA DEPTH.

contributing drainage area= $\frac{2373}{36}$ sq ft depth of stone media= $\frac{36}{36}$ inches paver area= $\frac{238}{36}$ sq ft CITY OF ATLANTA DEPARTMENT OF WATERSHED MANAGEMENT PLAN SUBMITTAL

1. REMOVE ACCUMULATED SEDIMENT AND DEBRIS FROM JOINT SPACE MONTHLY. OBSERVE THE PERMEABLE PAVER SYSTEM FOR EXCESSIVE PONDING DURING STORM EVENTS AND REPAIR AS

3. VACUUM, SWEEP, OR BLOW PERMEABLE PAVER SURFACE QUARTERLY TO KEEP THE SURFACE FREE OF SEDIMENT. NEW STONE MAY NEED TO BE SWEPT INTO

THE JOINTS AS NEEDED. 4. INSPECT PERMEABLE PAVER SURFACE FOR DETERIORATION ANNUALLY. REPAIR OR REPLACE ANY DAMAGED AREAS AS NEEDED.

ATTACH THIS TWO-PAGE PERMEABLE PAVER SPECIFICATION TO HOUSE **SPECIFICATIONS** PAGE 2 OF 2

**PERVIOUS PAVERS **C−2 NOT TO SCALE

November 2012

Total Proposed Impervious Area 2373 SF

RUNOFF REDUCTION DESCRIPTION:	
TOTAL IMPERVIOUS AREA FOR THE SITE IS 2,373 SQUARE FEET. RUNOFF REDUCTION IS PROVIDED FOR NEW IMPERVIOUS AREA FEET. SEE LOT COVERAGE CHART.	OF 2,373 SQUARE

SF

THERE WILL BE ONE PERVIOUS PAVERS AREA IN THE FRONT OF THE HOUSE IN THE DRIVEWAY. THE PERVIOUS PAVERS WILL DETAIN A TOTAL OF 2,373 SF OF IMPERVIOUS AREA, AS MENTIONED ABOVE. THE PAVERS WILL BE BUILT TO ATLANTA STANDARDS PER THE DETAILS ATTACHED.

THE REQUIRED RUNOFF REDUCTION VOLUME IS 197.8 CUBIC FEET. THE PROVIDED SURFACE AREA OF PAVERS WILL BE A MINIMUM OF 238 SF. THE REQUIRED #57 STONE DEPTH IS MINIMUM OF 3 FT FOR A TOTAL OF 258.6 CF. THE FINAL SHAPE AND ORIENTATION OF THE PAVERS AREA IS TO BE DETERMINED BY THE OWNER AND BUILDER GIVEN IT MEET THE REQUIREMENTS

RUNOFF REDUCTION VOLUMES PROVIDED BY THE BMP'S SHOWN EXCEEDS THE STORAGE REQUIREMENTS



" required for required area impervious

تو 2

CVE PI # 21-277 SHEET NO.

PROPOSED IMPERVIOUS AREA CALCULATIONS

Total Treated Impervious Area

RUNOFF REDUCTION IMPERVIOUS AREA CALCULATIONS Square Footage Not/Treated **BMP Location** Site Location (Sq. Ft.) TREATED FRONT Proposed House 1141 FRONT Proposed Front Porch TREATED TREATED FRONT 423 Proposed Garage 520 TREATED Proposed Driveway FRONT 150 TREATED FRONT Proposed Back Patio FRONT Proposed Wall TREATED

2373

Required Treated Impervious Area = 2373.0 **SF** Required Rr Volume = 197.8 **CF** Gravel Base Calculations Area of Trench 238.0 **FT Depth of Trench** 36.0 IN Provided Stone Storage = 285.6 **CF** Required Volume = CF 197.8 Provided Volume is Greater than Required Volume

FRONT - Pervious Pavers Calculations

Runoff Reduction Calculations

- THE CONSTRUCTION PAD SHALL BE MAINTAINED IN A CONDITION WHICH WILL PREVENT TRACKING OR FLOW OF MUD ONTO PUBLIC STREETS.
- 2. SILT FENCES AND HAY BALE BARRIERS SHALL BE CLEANED OR REPLACED AND MAINTAINED IN FUNCTIONAL CONDITION UNTIL PERMANENT EROSION CONTROL MEASURES ARE ESTABLISHED.
- 3. ALL WORK SHALL BE PERFORMED IN ACCORDANCE WITH THE SPECIFICATION OF THE MANUAL FOR EROSION AND
- SEDIMENT CONTROL IN GEORGIA. 4. THE CONTRACTOR SHALL CLEAN OUT ALL ACCUMULATED SILT FROM THE SEDIMENT PONDS ONCE ALL DISTURBED
- 5. EROSION CONTROL DEVICES WILL BE IN PLACE BEFORE SITE DISTURBANCE AND WILL BE PERIODICALLY INSPECTED AND REPAIRED OR RESTORED AS NEEDED TO FUNCTION PROPERLY UNTIL PERMANENT MEASURES ARE ESTABLISHED AND PROJECT IS COMPLETE, I.E.: CONSTRUCTION EXITS AND SILT FENCES SHALL BE RETOPPED OR CLEANED AS SILT REDUCES THEIR AFFECTIVENESS.
- 6. ANY ADDITIONAL CONSTRUCTION OTHER THAN SHOWN ON THIS PLAN WILL REQUIRE SEPARATE AND ADDITIONAL EROSION AND SEDIMENT CONTROL MEASURES AND APPROVAL.
- 7. TEMPORARY VEGETATION AND/OR HEAVY MULCH WILL BE USED TO STABILIZE AREAS. IN NO CASE SHALL A SITE BE LEFT BARE FOR MORE THAN 14 DAYS.
- 8. ALL DISTURBED AREAS WILL BE PERMANENTLY LANDSCAPED AND GRASSED AS SOON AS CONSTRUCTION PHASES
- 9. ADDITIONAL MEASURES MAY BE REQUIRED TO CONTROL EROSION AS DETERMINED NECESSARY BY INSPECTORS.
- 10. PERSON RESPONSIBLE FOR EROSION CONTROL MEASURES IS: 24 HOUR EMERGENCY CONTACT: CHUBA AMADI 404-477-4971
- 11. CUT AND FILL SLOPES NOT TO EXCEED 2H:1V.

AREAS ARE STABILIZED WITH PERMANENT VEGETATION.

- 12. SEDIMENTATION & EROSION CONTROL MEASURES TO BE INSPECTED DAILY.
- 13. NO WETLANDS EXIST ON OR WITHIN 200 FEET OF THE PROJECT SITE.
- 14. IT IS THE RESPONSIBILITY OF THE PROPERTY OWNERS OF THE STORMWATER MANAGEMENT FACILITY TO KEEP THE ACCESS DRIVE FREE OF OBSTRUCTIONS AND TO MAINTAIN THE FACILITY FREE OF OBSTRUCTIONS, SILT AND DEBRIS, AND OPERATIONAL
- 15. DETENTION POND, DETENTION OUTLET STRUCTURES AND TEMPORARY SEDIMENT POND FEATURES ARE TO BE CONSTRUCTED AND FULLY OPERATIONAL PRIOR TO ANY OTHER CONSTRUCTION OR GRADING.
- 16. DEVELOPER IS TO CLEAN OUT ACCUMULATED SILT IN DETENTION POND AT END OF CONSTRUCTION WHEN DISTURBED AREAS HAVE BEEN STABILIZED.
- 17. ACCESS EASEMENT TO BE CLEARED AND GRUBBED.

SILT FENCE PROVIDED = 252 LINEAR FEET

SEDIMENT STORAGE REQUIRED = 6.34 CU YD SEDIMENT STORAGE PROVIDED = 12.60 CU YD

CITY OF ATLANTA ES PC NOTES:

THE ESCAPE OF SEDIMENT FROM THE SITE SHALL BE PREVENTED BY THE INSTALLATION OF SEDIMENT AND EROSION CONTROL MEASURES PRIOR TO OR CONCURRENT WITH LAND DISTURBING ACTIVITIES.

EROSION CONTROL MEASURES WILL BE MAINTAINED AT ALL TIMES. IF FULL IMPLEMENTATION OF THE APPROVED PLAN DOES NOT PROVIDE FOR EFFECTIVE EROSION CONTROL, ADDITIONAL EROSION AND SEDIMENT CONTROL MEASURES SHALL BE IMPLEMENTED TO CONTROL OR TREAT SEDIMENT AT THE SOURCE.

DISTURBED AREAS IDLE FOR 14 DAYS SHALL BE STABILIZED WITH TEMPORARY VEGETATION; DISTURBED AREAS IDLE FOR 30 DAYS SHALL BE STABILIZED WITH PERMANENT VEGETATION.

EROSION AND SEDIMENT CONTROL MEASURES SHALL BE INSPECTED AT LEAST WEEKLY, AFTER EACH RAIN, AND REPAIRED AS NECESSARY.

ADDITIONAL EROSION AND SEDIMENT CONTROL MEASURES SHALL BE INSTALLED IF DETERMINED NECESSARY BY ON-SITE INSPECTION.

SILT FENCE SHALL BE "TYPE-C" AS PER THE MANUAL FOR EROSION AND SEDIMENT CONTROL IN GEORGIA, AND BE WIRE REINFORCED (SEE ATTACHED DETAIL).

SITE AREAS:

TOTAL SITE ACRES = 0.190 ACRES TOTAL DISTURBED AREA = 0.095 ACRES

SOIL TYPES:

APPLING-HARD LABOR COMPLEX, 6 TO 10 PERCENT SLOPES GaE - GROVER-MOUNTAIN PARK COMPLEX, 10 TO 20 PERCENT SLOPES, STONY


THE ESCAPE OF SEDIMENT FROM THE SITE SHALL BE PREVENTED BY THE INSTALLATION OF EROSION AND SEDIMENT CONTROL MEASURES AND PRACTICES PRIOR TO, OR CONCURRENT WITH, LAND-DISTURBING

EROSION CONTROL MEASURES WILL BE MAINTAINED AT ALL TIMES. IF FULL IMPLEMENTATION OF THE APPROVED PLAN DOES NOT PROVIDE FOR EFFECTIVE EROSION CONTROL, ADDITIONAL EROSION AND SEDIMENT CONTROL MEASURES SHALL BE PROVIDED BY THE CONTRACTOR FOR EFFECTIVE EROSION IMPLEMENTED TO CONTROL OR TREAT THE SEDIMENT SOURCE.

ANY DISTURBED AREAS LEFT EXPOSED FOR A PERIOD GREATER THAN 14 DAYS SHALL BE STABILIZED WITH MULCH OR TEMPORARY SEEDING.


ANY DISTURBED AREAS REMAINING IDLE FOR 30 DAYS SHALL BE STABILIZED WITH PERMANENT

VEGETATION.

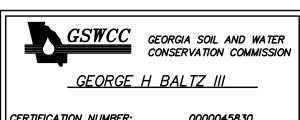

ISSUED: 09/25/2007


EXPIRES: 11/10/2025

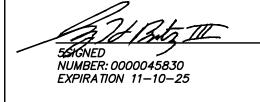

STATE WATER STATEMENT:

THIS PROPERTY IS NOT LOCATED INSIDE DESIGNATED F.I.A SPECIAL FLOOD HAZARD AREA AS PER THE FLOOD INSURANCE RATE MAP #13121C0228F, DATED SEPTEMBER

THERE ARE WATERS OF THE STATE OF GEORGIA LOCATED ON OR WITHIN 200 FEET OF THE SITE. ALL APPROPRIATE STATE WATER BUFFERS ARE SHOWN ON THE SITE PLANS.

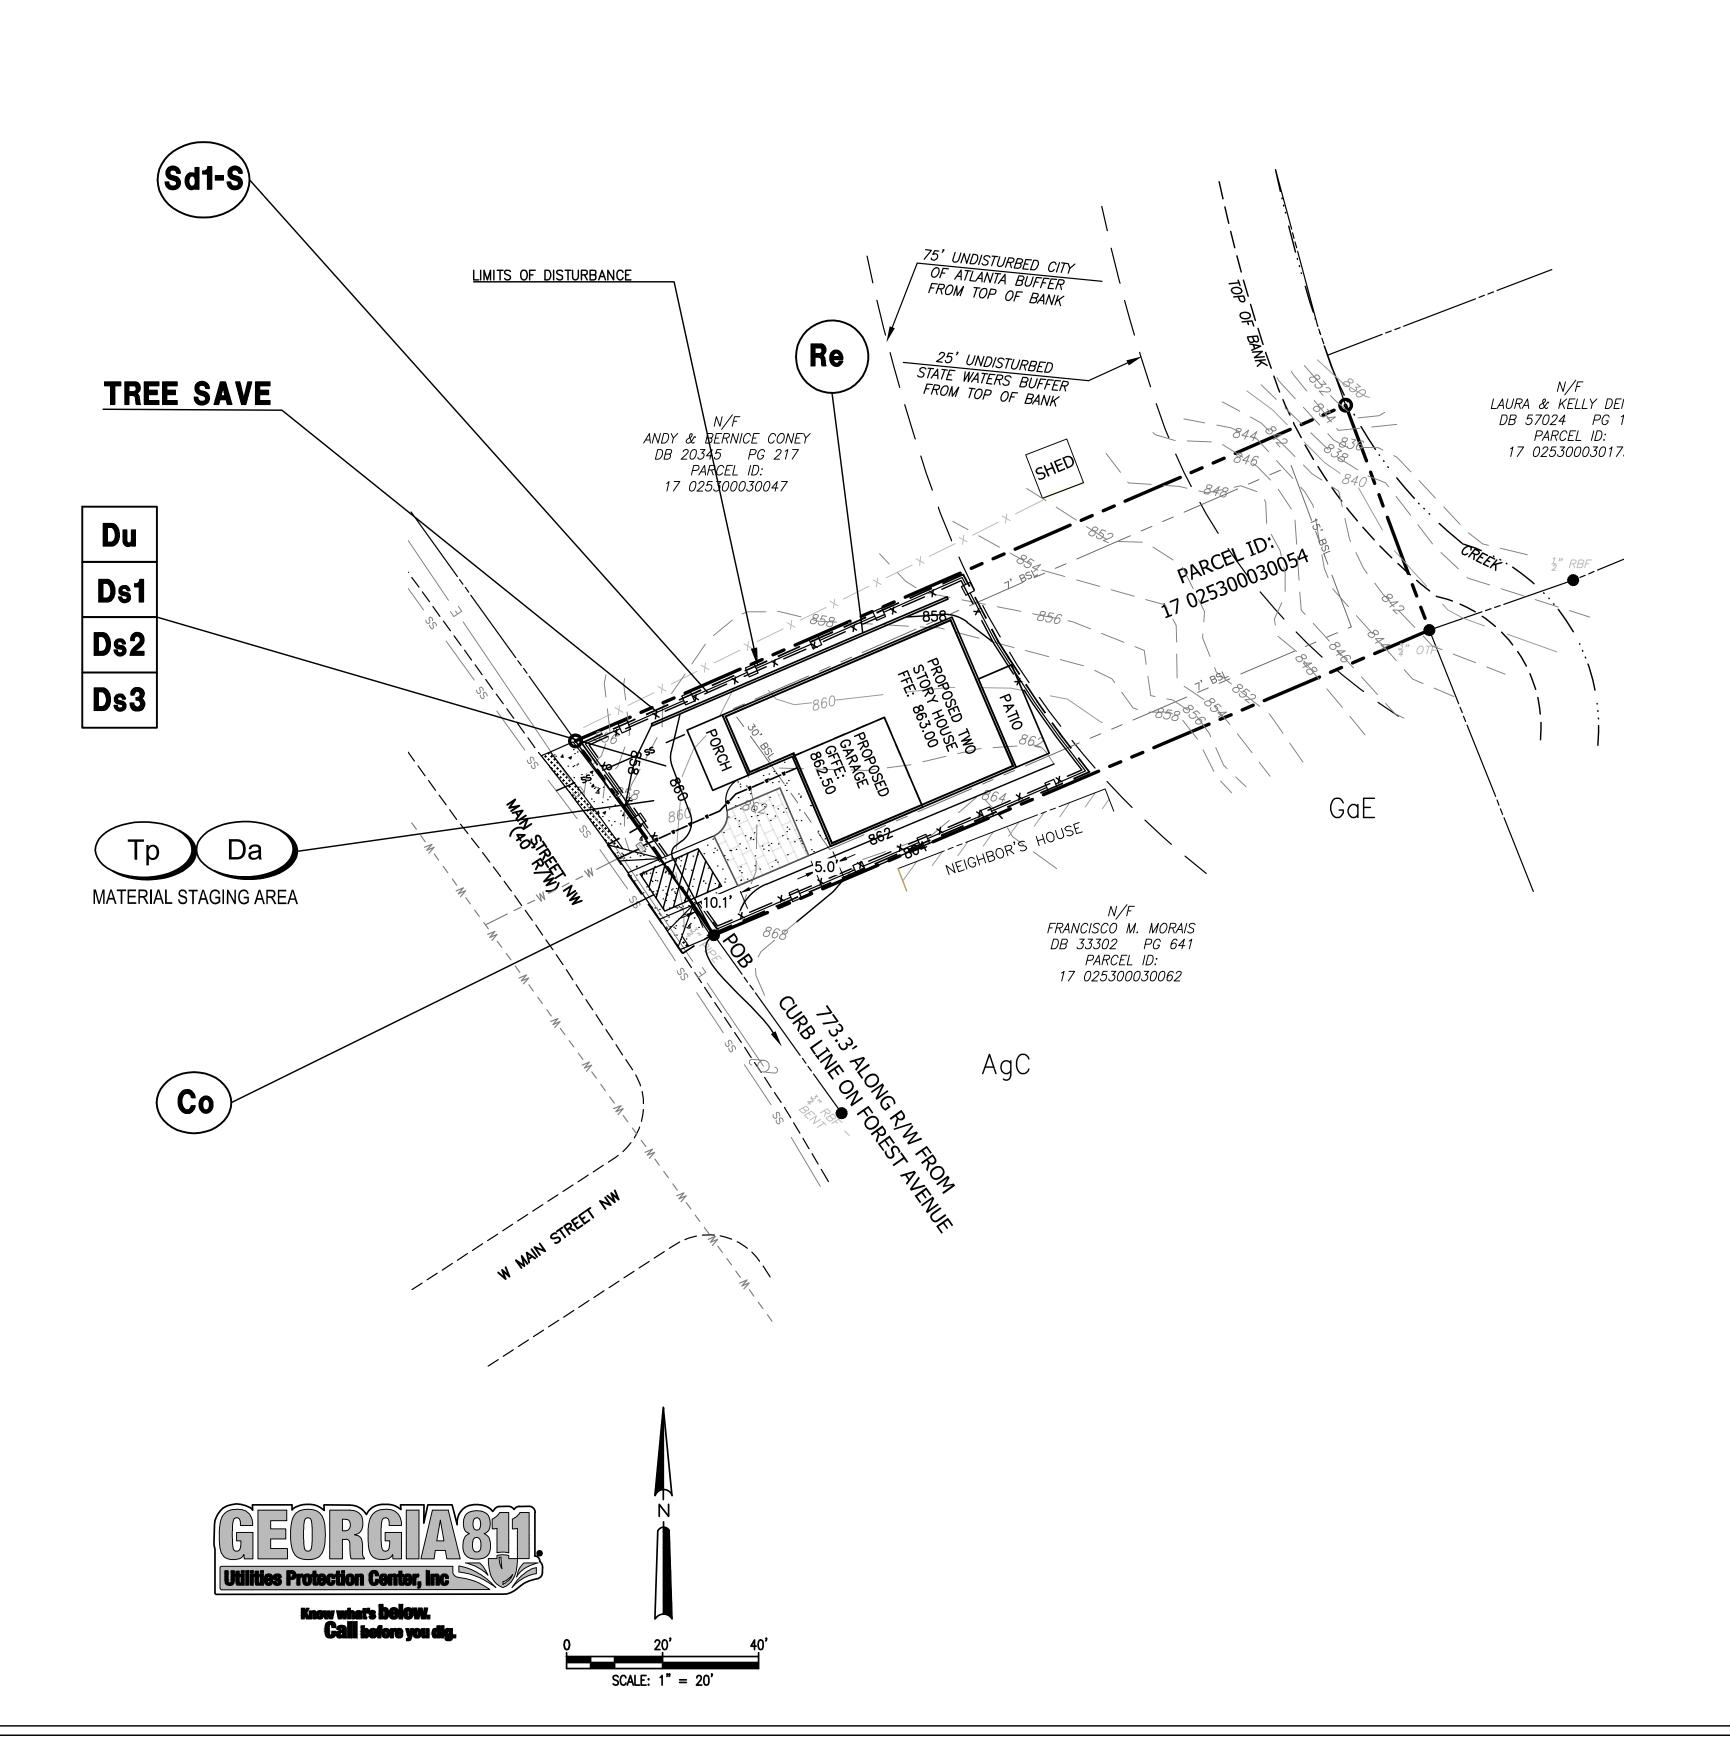

CVE PI # 21-277

SHEET NO.